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IBI Group Architects (Canada) Inc.

IBI Group Architects (C

SUB-CONSULTANT

NO. DATE APPR

DESCRIPTION

REVISIONS

PROJECT CONSULTANT

IBI GROUP
ARCHITECTS (CANADA) INC.
700 – 1285 West Pender Street
Vancouver BC V6E 4B1 Canada
tel 604 683 8797 fax 604 683 0492
ibigroup.com

THE BENNETT,
BURNABY, BC

PROJECT NO: 116939

DRAWN BY:

CHK'D BY:

SCALE: 3/32" = 1'-0"

DATE: 2019 AUGUST

SHEET TITLE

LEVEL 2

SHEET NUMBER





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LEDINGHAM McALLISTER Building BC since 1905

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REVISIONS

DESCRIPTION

NO. DATE APPR

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PROJECT CONSULTANT


IBI GROUP
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tel 604 683 8797 fax 604 683 0492
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THE BENNETT, **BURNABY**, BC

PROJECT NO: 116939 DRAWN BY: CHK'D BY: SCALE: 3/32" = 1'-0" DATE: 2019 AUGUST

SHEET TITLE

LEVELS 3-6

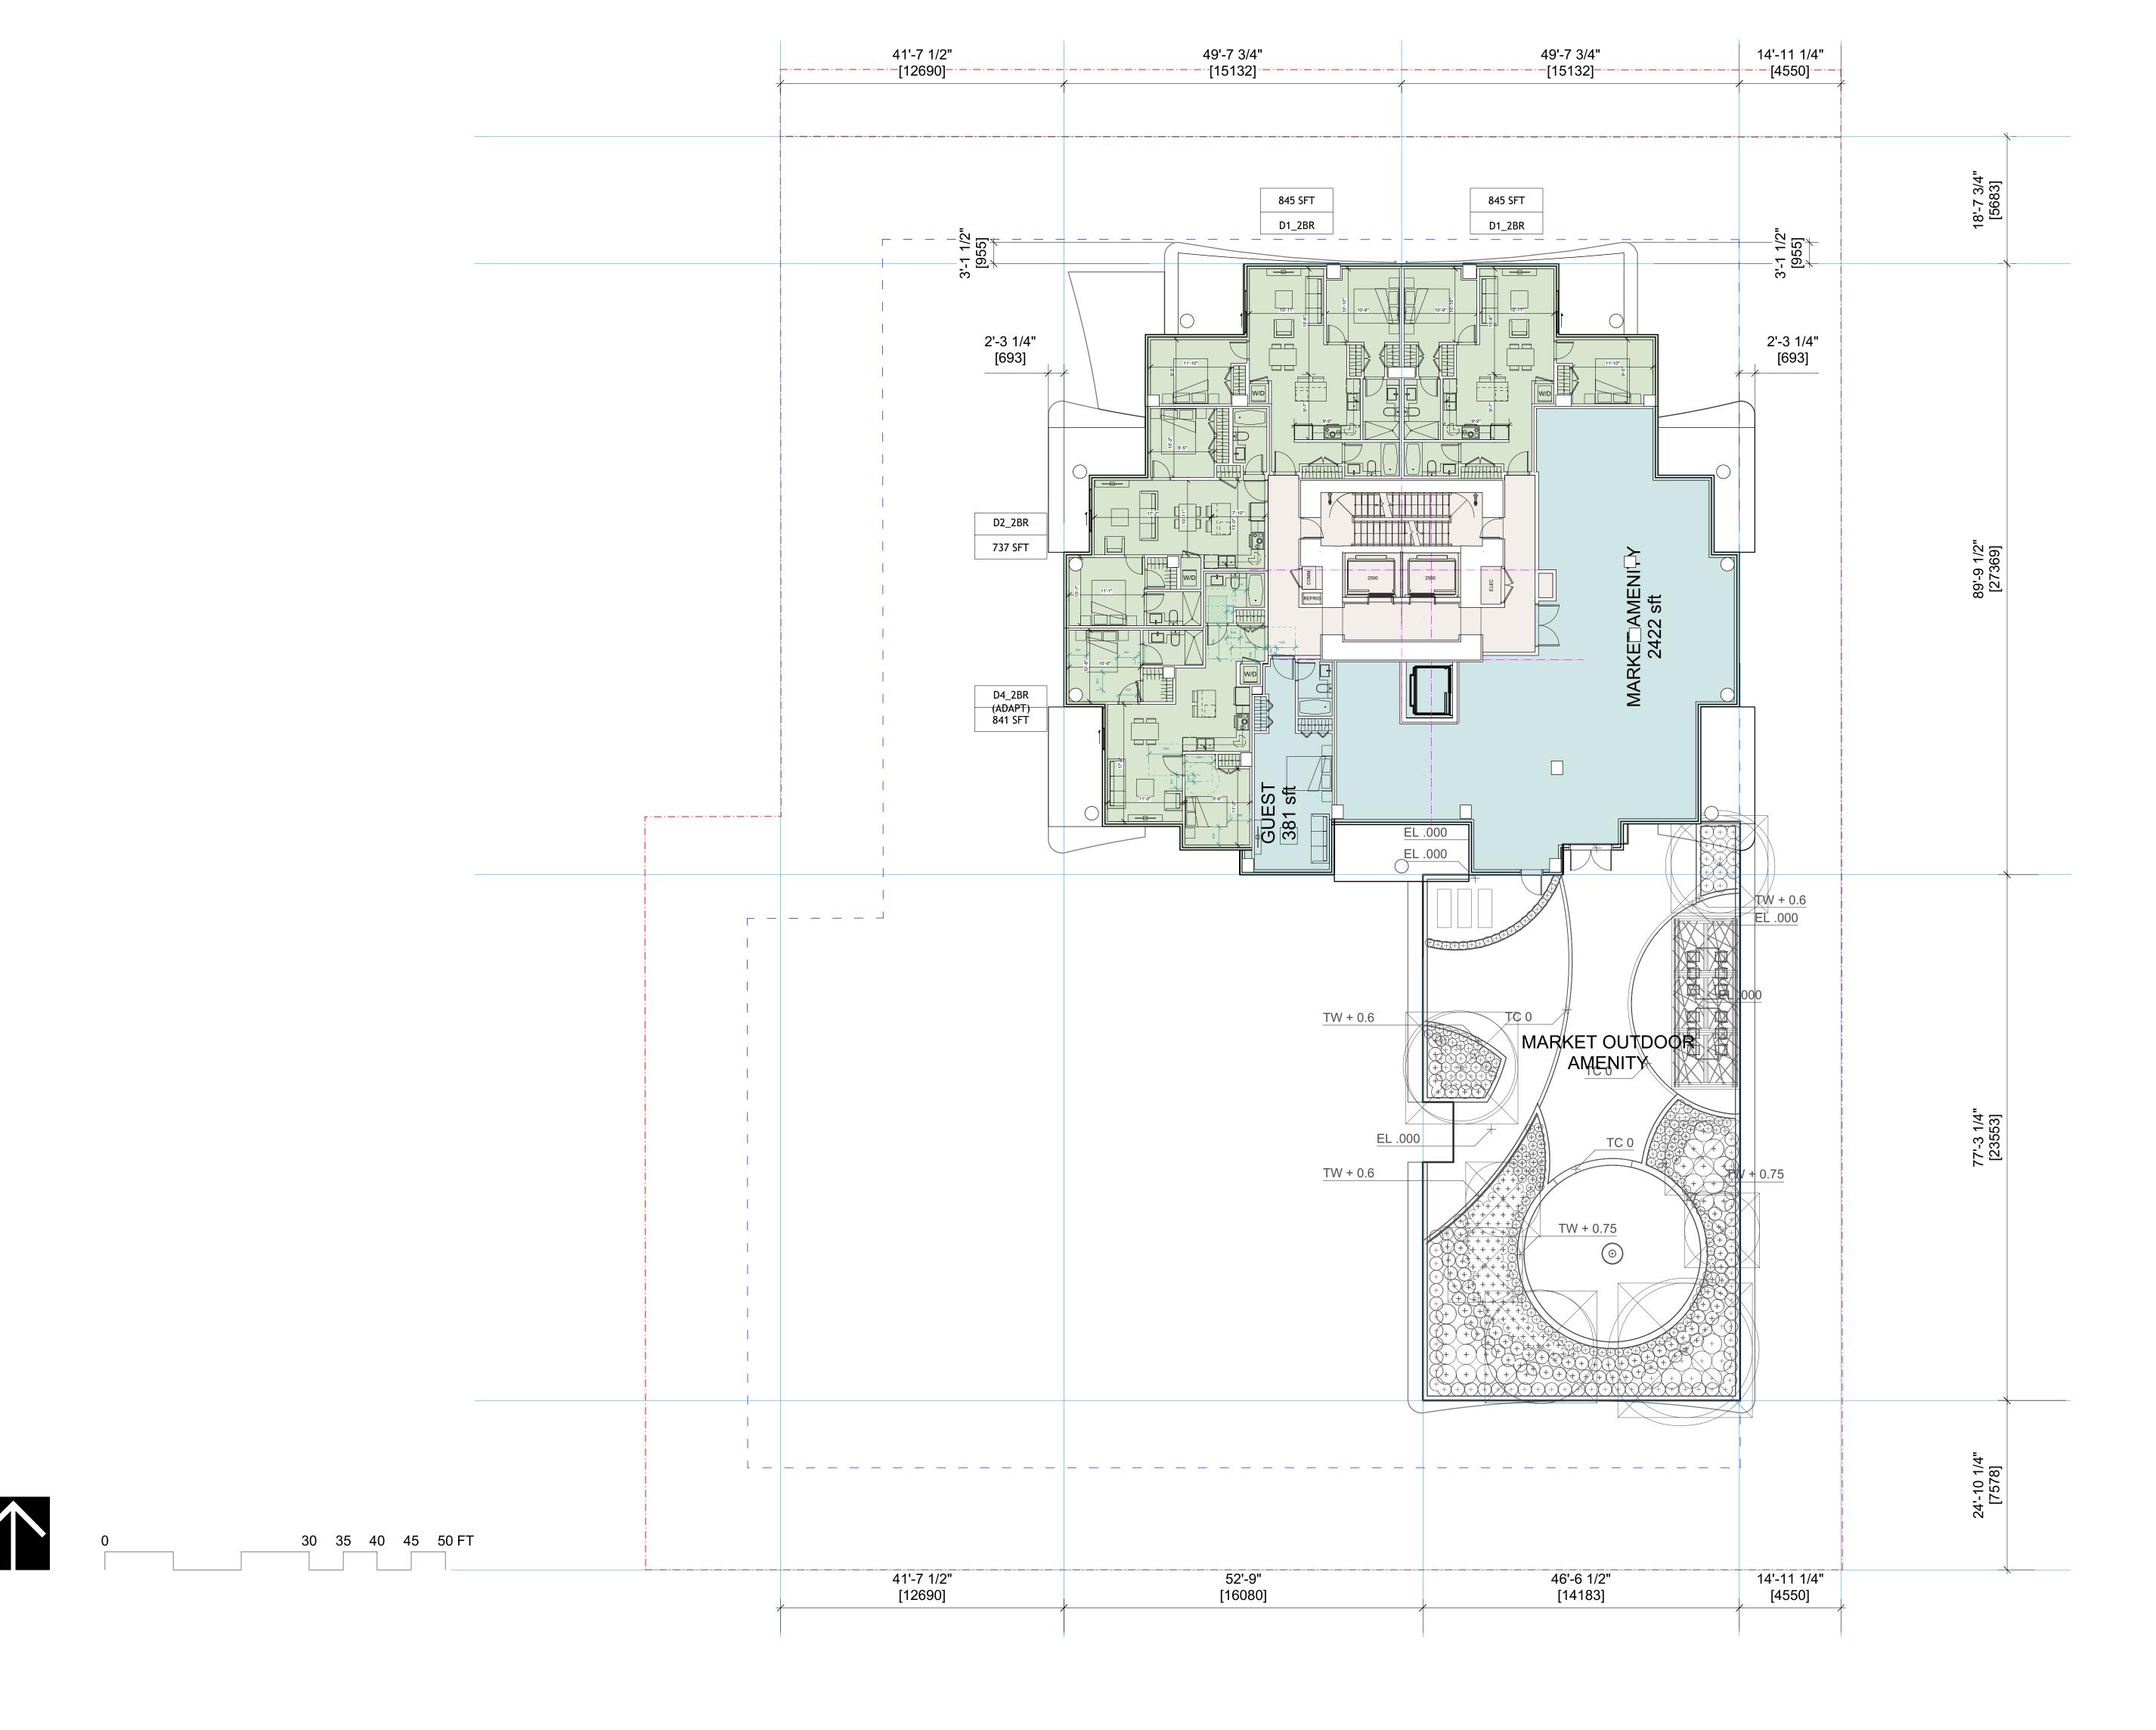

CLIENT

LEDINGHAM MCALLISTER

Building BC since 1905

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IBI Group Architects (Canada) Inc.

Is a member of the IBI Group of companies

Description

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SUB-CONSULTANT

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THE BENNETT,
BURNABY, BC

PROJECT NO: 116939

DRAWN BY:

CHK'D BY:

SCALE: 3/32" = 1'-0"

DATE: 2019 AUGUST

SHEET TITLE

LEVEL 7

SHEET NUMBER



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IBI Group Architects (Canada) Inc.

01	AUG 2019	ISSI	UED FOR REZONING
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NO.	DATE	APPR	
DEV/	ISIONS	1	

DESCRIPTION

SUB-CONSULTANT

PROJECT CONSULTANT



PROJECT TITLE


THE BENNETT, **BURNABY**, **BC** 


PROJECT NO: 116939 DRAWN BY: CHK'D BY: SCALE: 3/32" = 1'-0"


SHEET TITLE


LEVEL 8

SHEET NUMBER

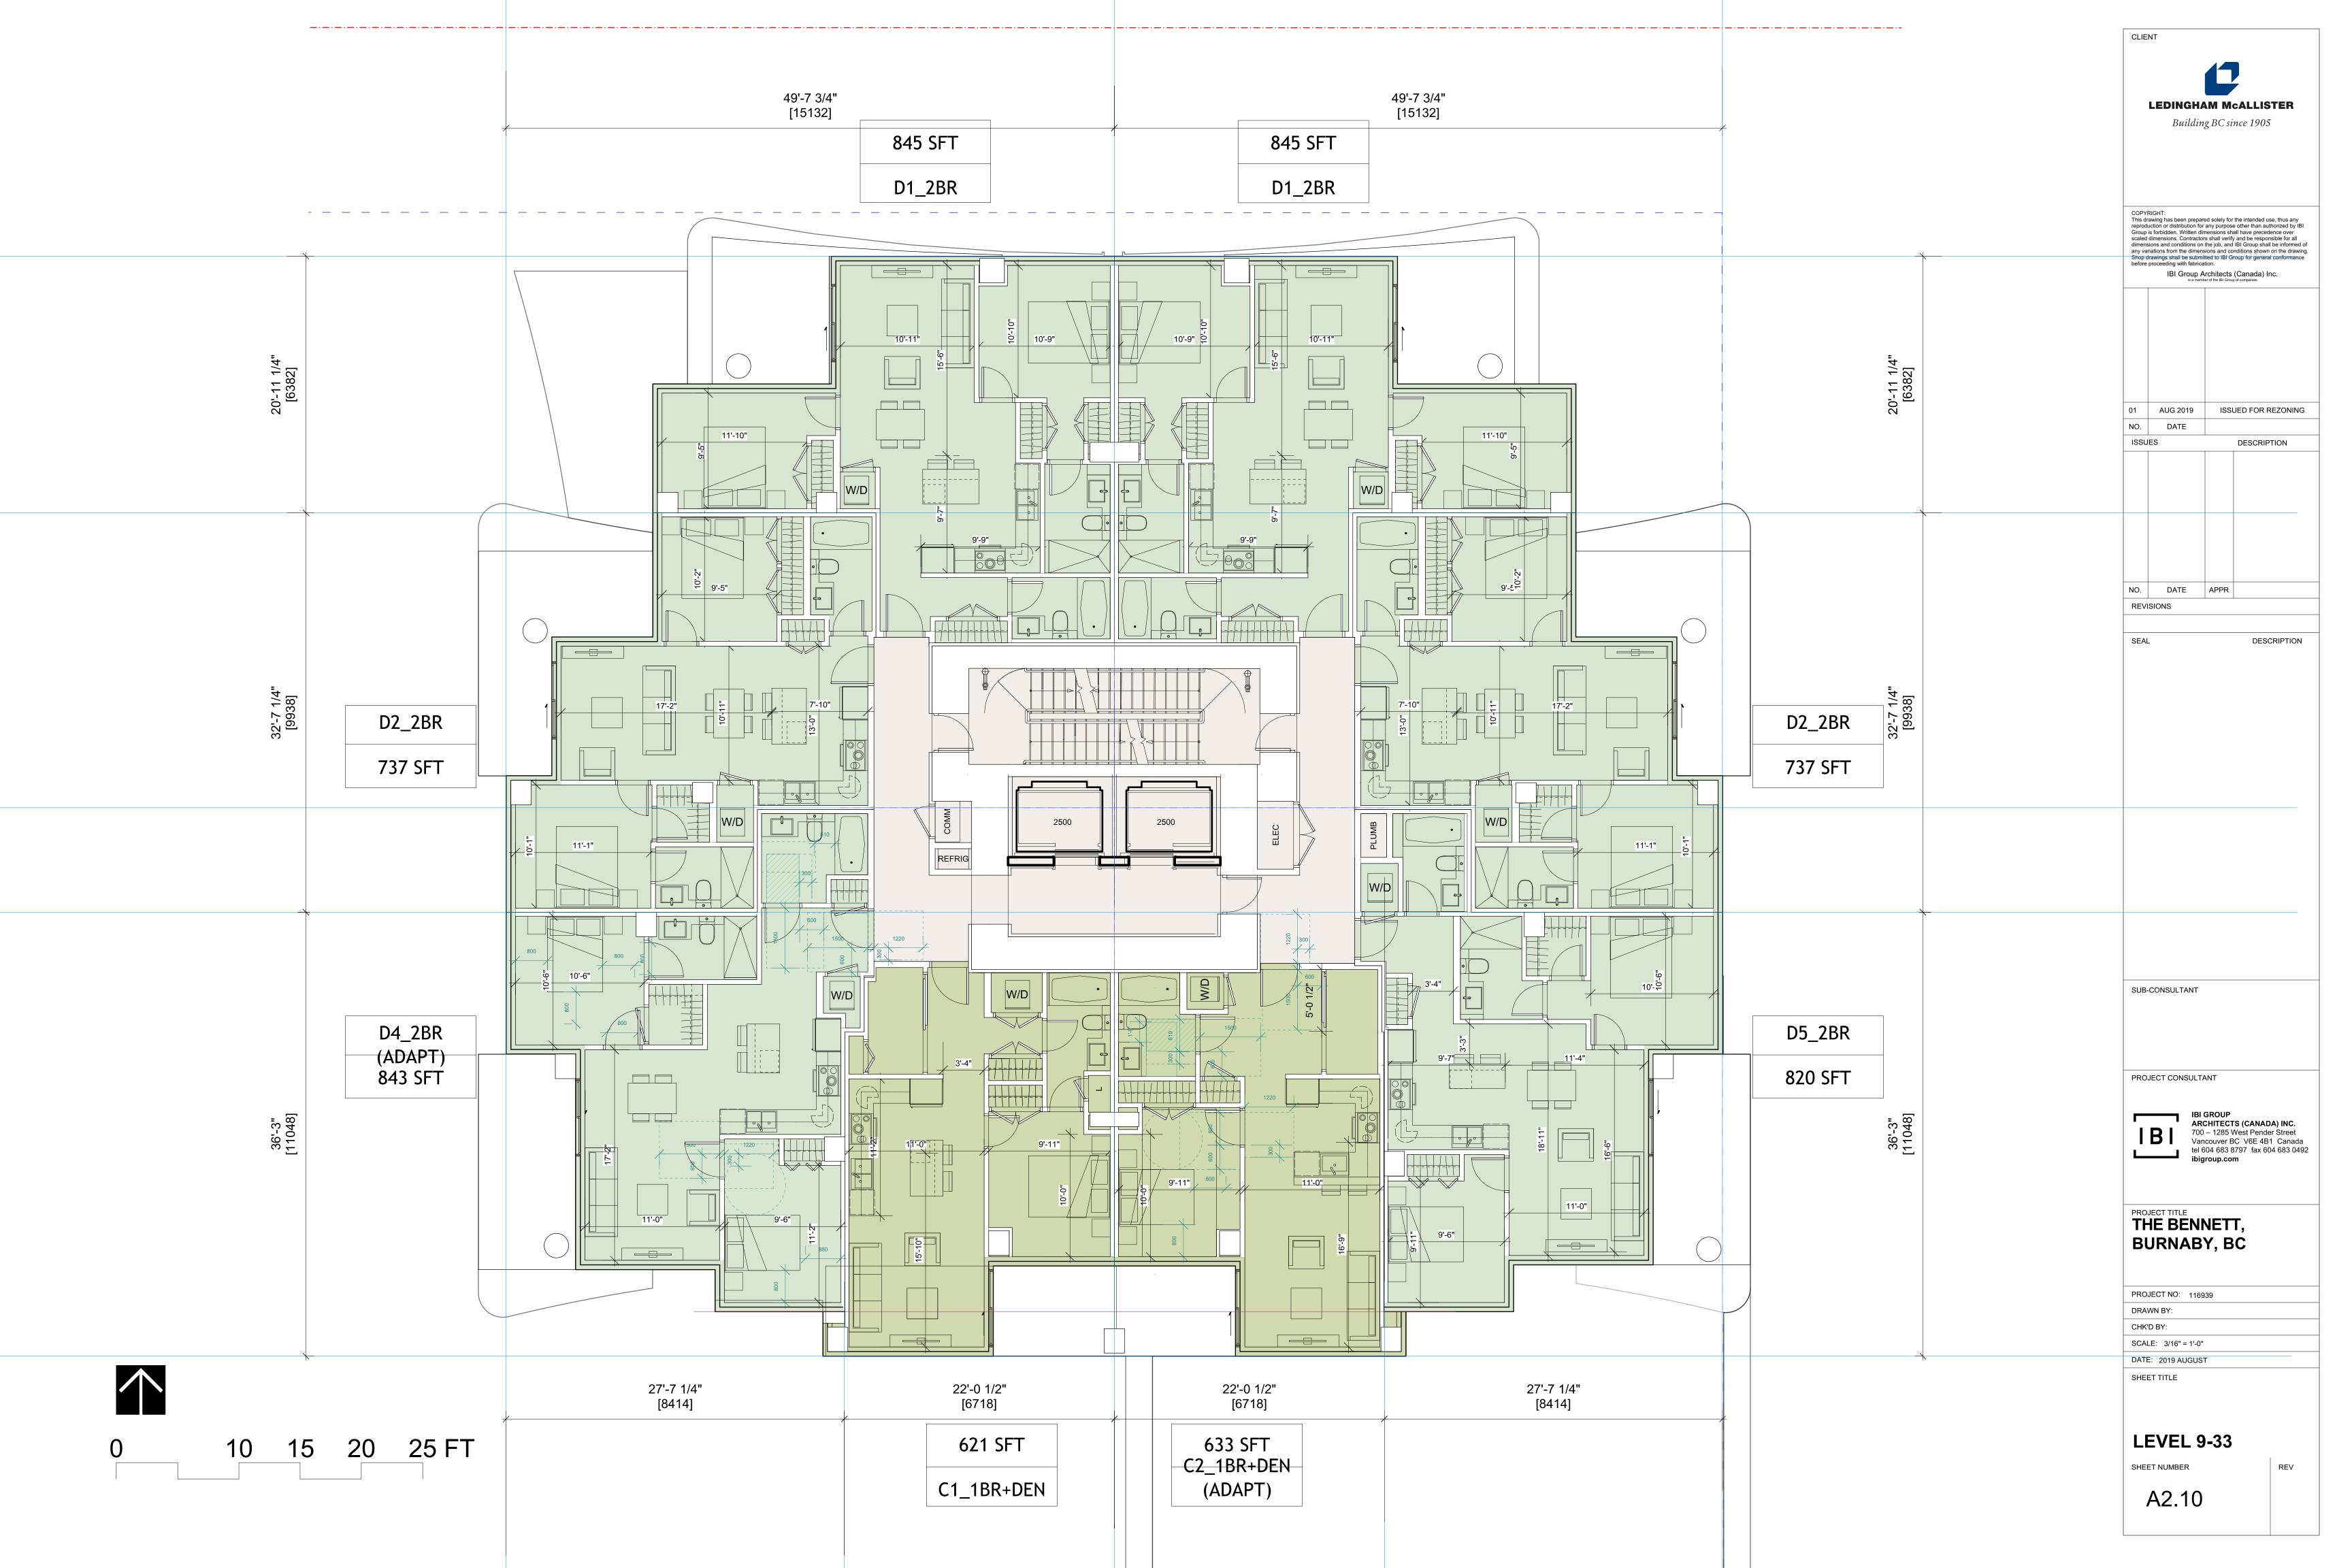

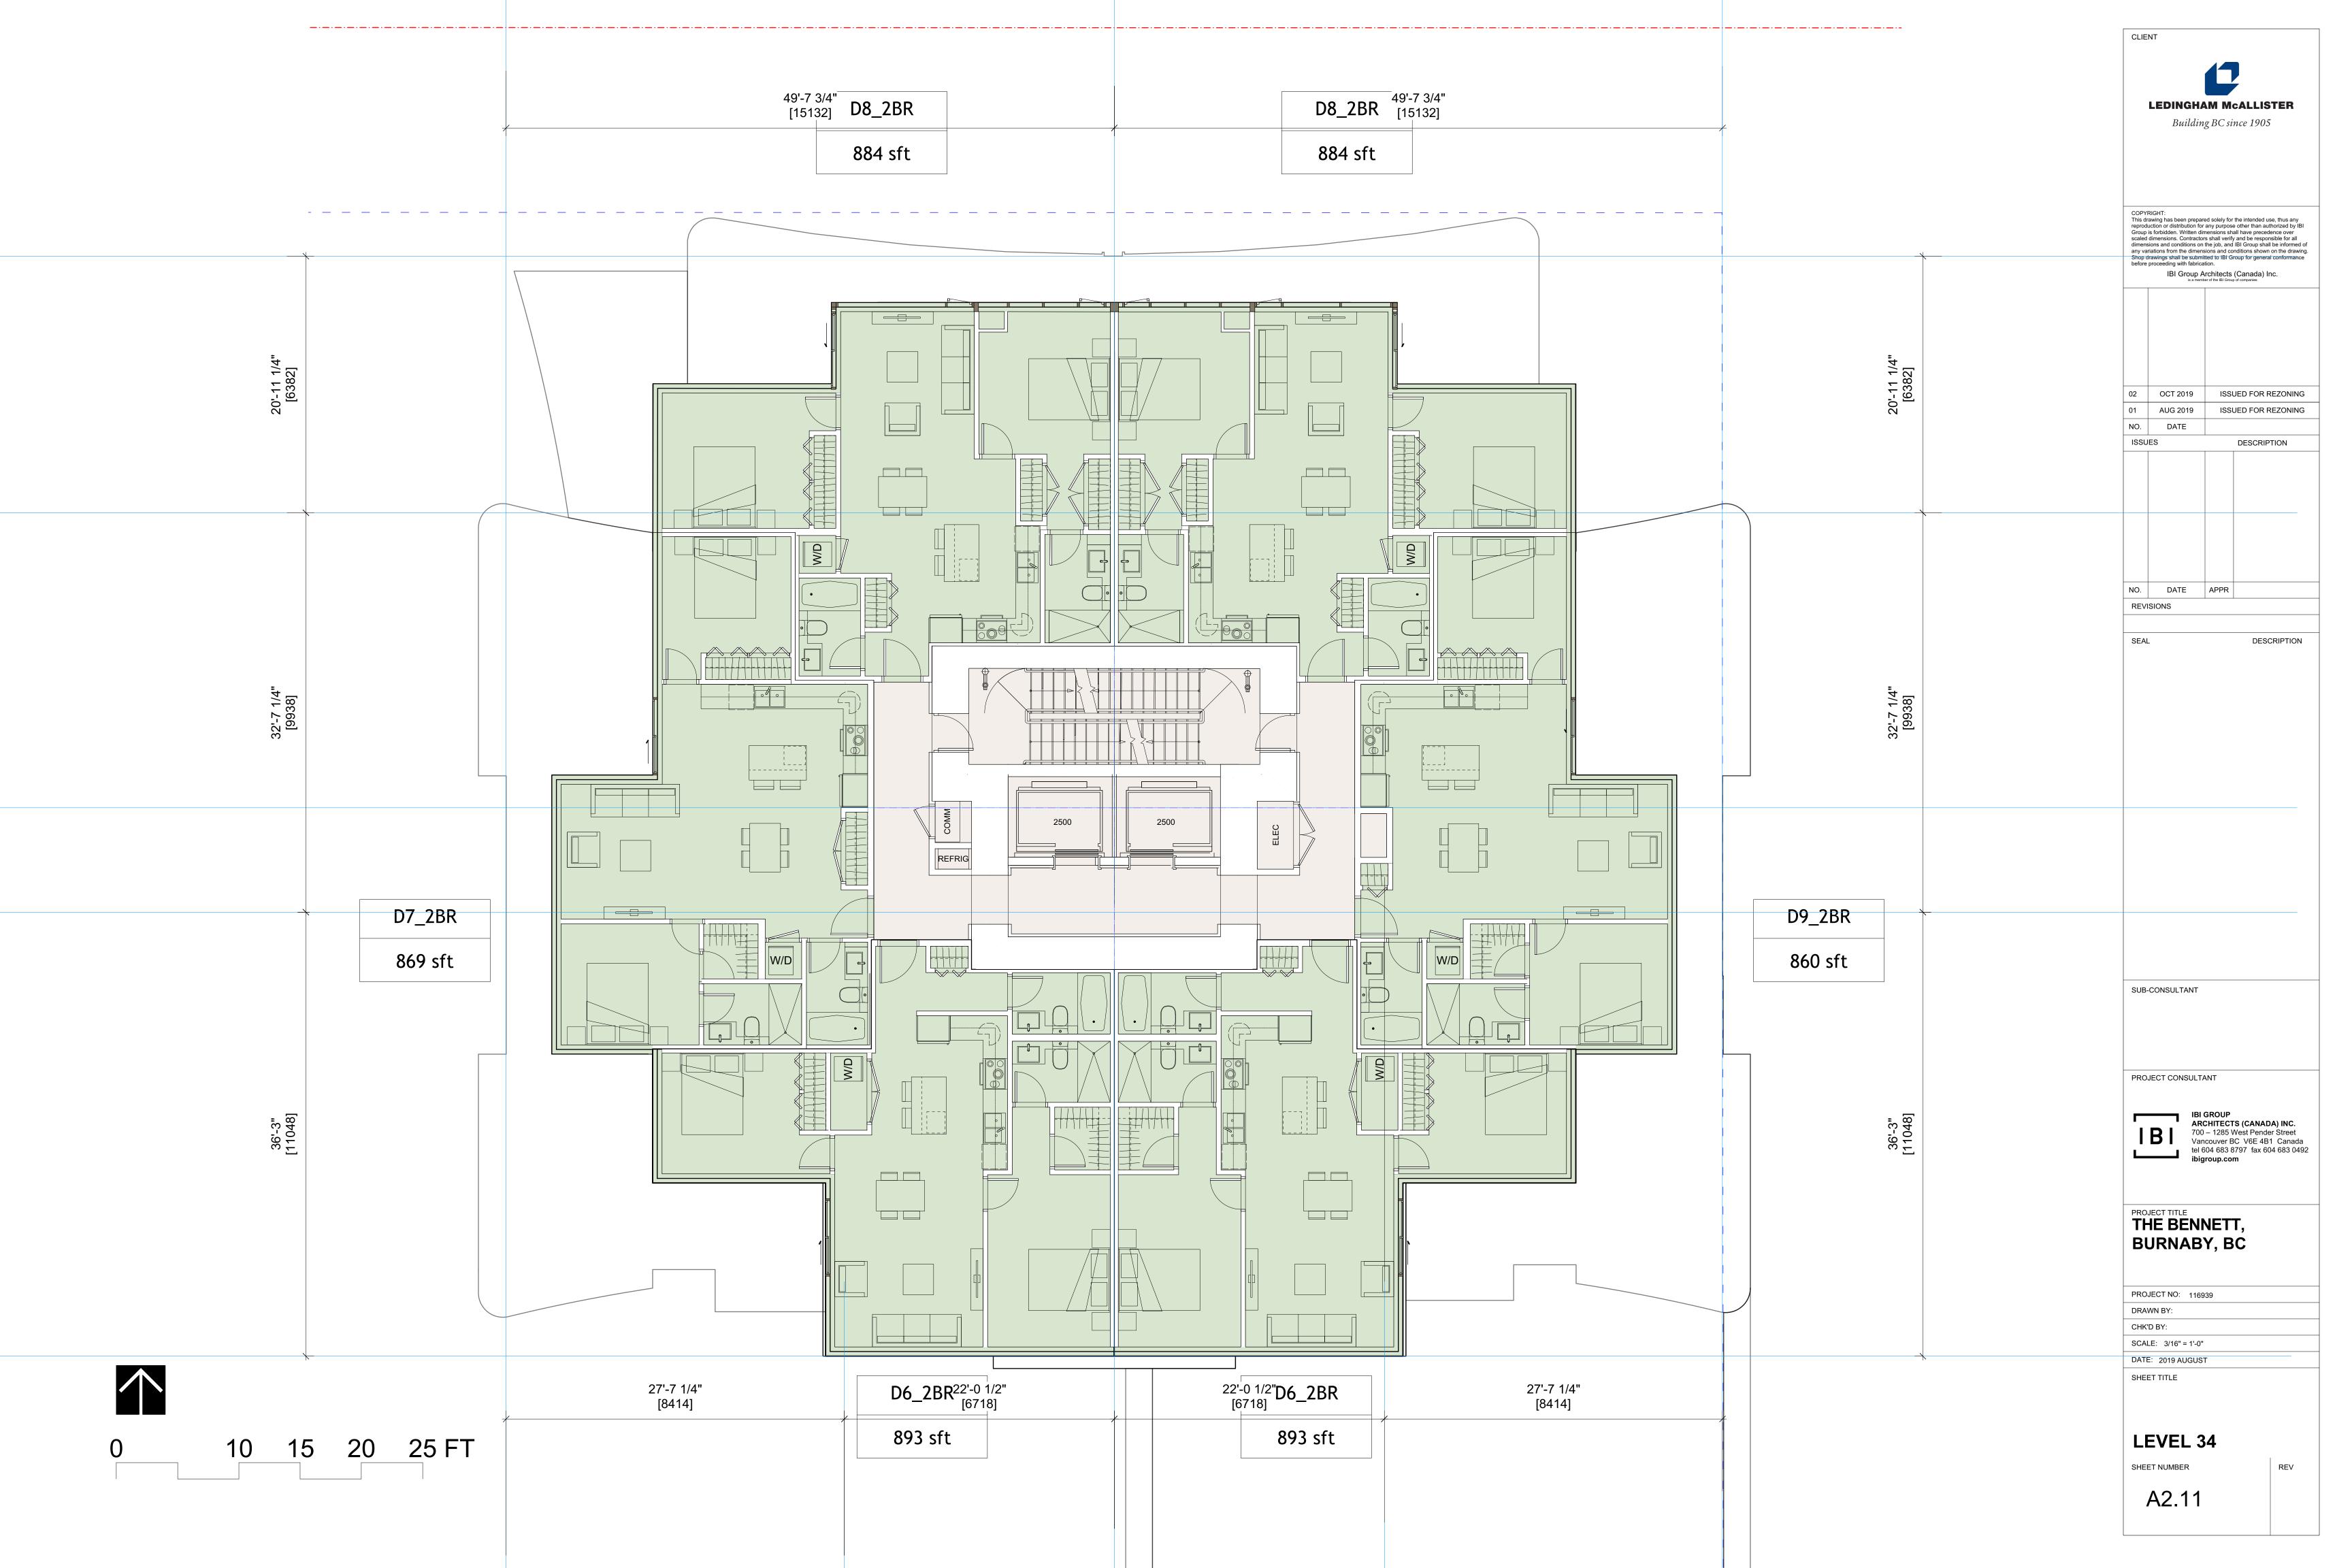

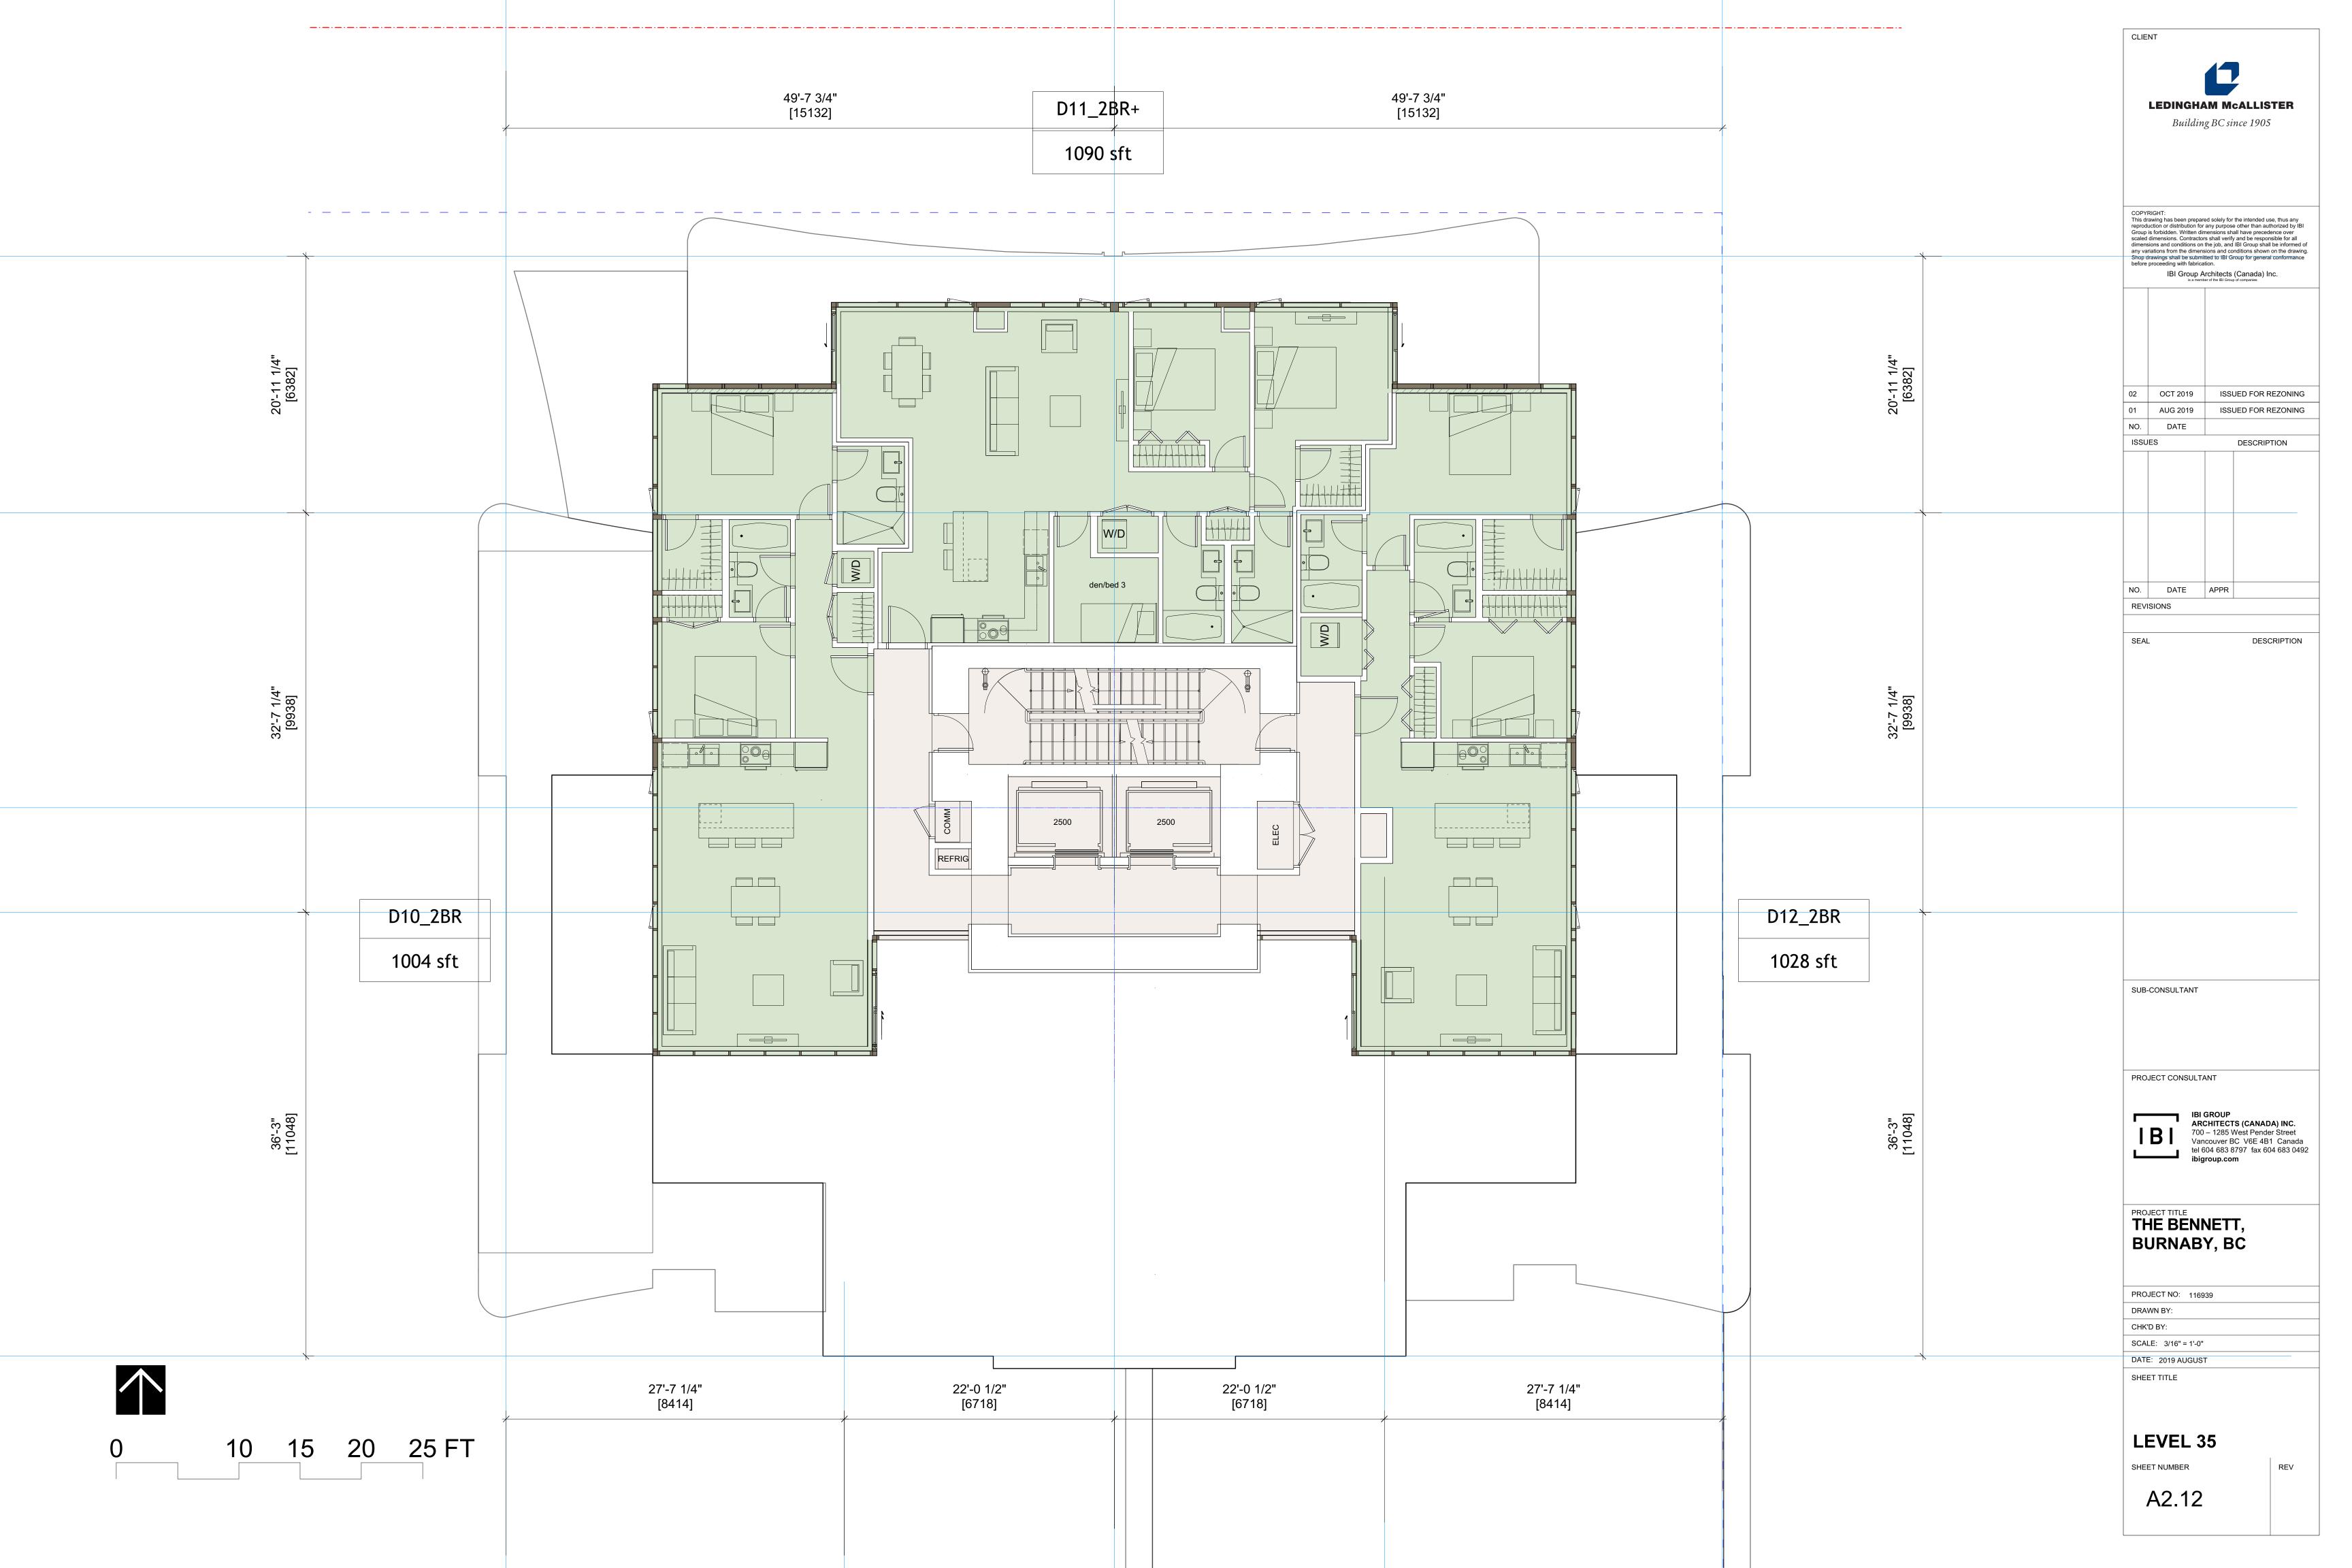


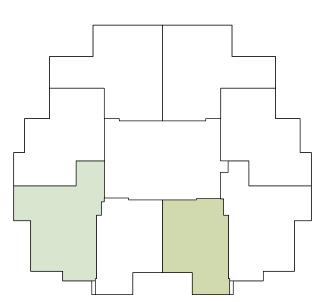


## **TOTAL UNITS PROVIDED:**

24 2BDS 24 1BDS 48 UNITS 20% OF UNIT TOTAL

ADAPTABLE UNITS				
LEVELS	1BD	2BD	3BD	TOTAL
34				0
33				0
32	1			1
31	1			1
30	1			1
29	1			1
28	1			1
27	1			1
26	1	1		2
25	1	1		2
24	1	1		2
23	1	1		2
22	1	1		2
21	1	1		2
20	1	1		2
19	1	1		2
18	1	1		2
17	1	1		2
16	1	1		2
15	1	1		2
14	1	1		2
13	1	1		2
12	1	1		2
11	1	1		2
10	1	1		2
9	1	1		2
8		1		
7		1		<u>.</u> 1
6		1		<u>.</u> 1
5		1		<u>.</u> 1
4		1		<u>.</u> 1
3		1		<u>.</u> 1
2		-		0
1				0
TOTAL	24	24	0	<u></u> 48
IVIAL	27	<b>4</b>	<u> </u>	

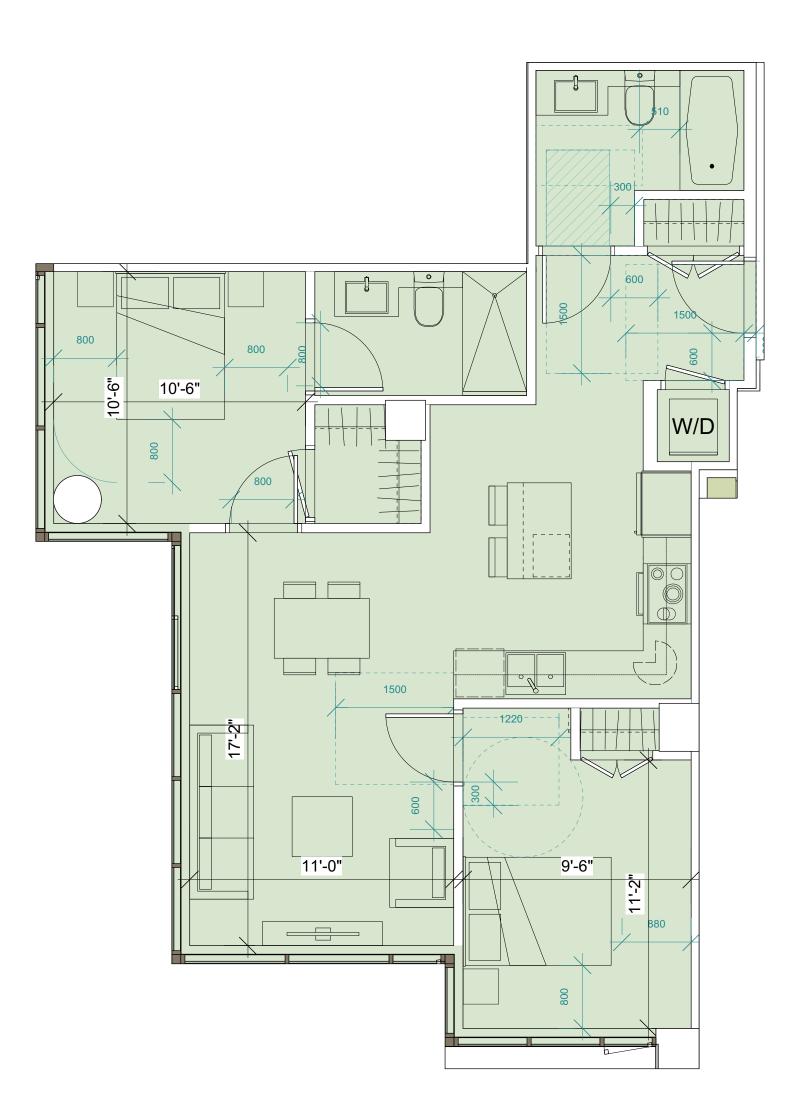

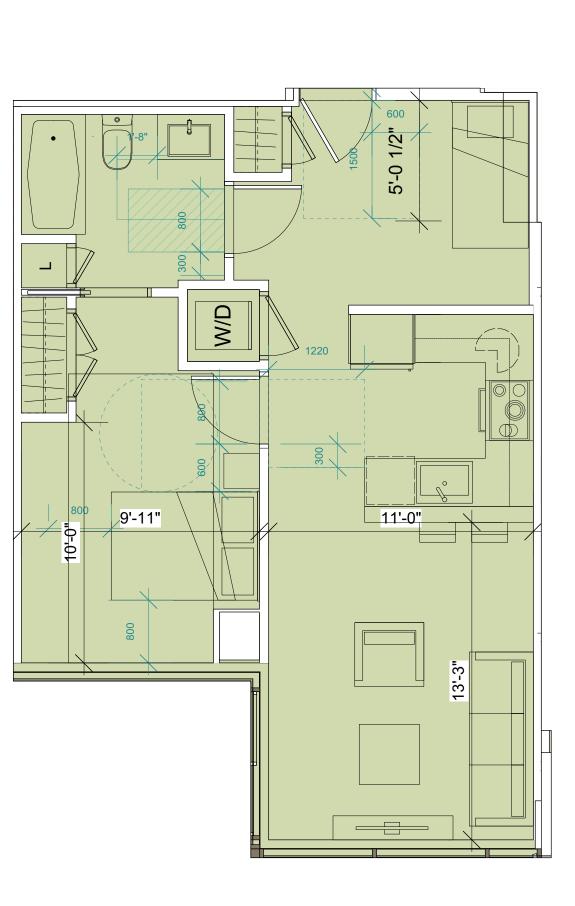

#### A. <u>BUILDING ENTRY AND CIRCULATION</u>

The following guidelines allow for visitability to a residential development.

ADAPTABLE FEATURE	PROVIDED
<ul> <li>An accessible path of travel shall be provided:</li> <li>from the street, surface, passenger-loading zones and/or underground parking area to at least one main entrance;</li> <li>from the main entrance to each adaptable unit;</li> <li>from the main entrance to the elevator; and,</li> <li>from the main entrance to all common facilities or amenities (i.e. lounge, party room, pool/sauna, fitness room, guest suite).</li> </ul>	
Elevator entrances shall provide a clear area of not less than 1,500 mm x 1,500 mm on a floor where adaptable units or common facilities or amenities are located.	
Corridors and passage ways providing access to adaptable dwelling unit entrances and common facilities or amenities shall be not less than 1,220 mm in width.	
Door handles shall not require tight grasping or twisting of the wrist.	

#### B. <u>UNIT ENTRY</u>

The following guidelines provide basic clearance for a wheelchair or other mobility device to enter and exit an adaptable dwelling unit.

ADAPTABLE FEATURE	PROVIDED
Unit suite entry shall have a minimum clear opening of not less than 850 mm.	
<ul> <li>When the door swings out (away from the unit entry area), a minimum clearance of 1220 mm will be provided in the common corridor to accommodate the door swing movement. A 300 mm clear space beside the latching jamb of the door will also be provided.</li> <li>When the door swings in (towards the unit entranceway), a minimum clearance of 1500 mm will be provided in the entranceway to accommodate the door swing movement. A 600 mm clear space beside the latching jamb of the door will also be provided.</li> </ul>	
Door handles shall not require tight grasping or twisting of the wrist.	

#### C. <u>INTERNAL DOORWAYS AND CORRIDORS (WITHIN ADAPTABLE UNIT)</u>

The following guidelines provide basic clearance and maneuvering space for a wheelchair or other mobility device to access common living areas and rooms of an adaptable dwelling unit.

ADAPTABLE FEATURE	PROVIDED
All doorways providing access to all living areas within the unit shall have a clear minimum opening width of not less than 810 mm.	
<ul> <li>When the door swings out, a minimum clearance of 1220 mm will be provided in the corridor to accommodate the door swing movement. A 300 mm clear space beside the latching jamb of the door will also be provided.</li> <li>When the door swings in, a minimum clearance of 1500 mm will be provided in the entranceway to accommodate the door swing movement. A 600 mm clear space beside the latching jamb of the door will also be provided.</li> </ul>	
Internal unit corridors and passageways shall be a minimum of 850 mm in width.	
Door handles shall not require tight grasping or twisting of the wrist.	

#### D. <u>KITCHEN</u>

The following guidelines provide an efficient kitchen layout with basic clearance and maneuvering space for a wheelchair or other mobility device. Equipment, controls, switches, and outlets within the kitchen are to be within easy reach and use.

ADAPTABLE FEATURE	PROVIDED
A kitchen shall be designed such that the range and sink are adjacent to each other or can have a continuous counter between them.	
Controls and switches including electrical, telephone, cable and data outlets shall be located between 455 mm and 1200 mm above the floor.	

#### E. <u>BATHROOM(S)/POWDER ROOM(S)</u>

The following guidelines provide basic clearance and maneuvering space for a wheelchair or other mobility device to access all bathroom(s) and/or powder room(s) within an adaptable dwelling unit. Construction requirements to reinforce bathroom walls such that they are able to accommodate the future installation of grab bars are a cost-savings to residents seeking to renovate the bathroom(s) to meet their mobility needs.

ADAPTABLE FEATURE	PROVIDED
A clear dimension of 800 mm from the front edge of the toilet to the facing wall, or edge of the tub if applicable, shall be provided.	
A minimum dimension of 510 mm shall be provided from the front face of the bathtub/shower to the centre line of the toilet.	
A minimum of one bathroom shall be designed with a clear floor area in front of the sink not less than 760 mm wide by 1350 mm deep, centred on the toilet.	
Walls adjacent to the toilet, bathtub or shower shall accommodate the future installation of grab bars.	
Faucets shall be designed to be operable without tight grasping, pinching or twisting of the wrist.	
A clear floor space, exclusive of door swing, not less than 760 mm wide by 1350 mm deep connecting to the route through the doorway.	
Controls and switches including electrical, telephone, cable and data outlets shall be located between 455 mm and 1200 mm above the floor.	

#### F. LIVING ROOMS AND BEDROOM(S)

The following guidelines provide basic clearance and maneuvering space for a wheelchair or other mobility device to access all living rooms and bedrooms within an adaptable dwelling unit. Areas identified on the architectural plans as living rooms and bedrooms should be illustrated with furniture to scale with the size and dimensions of the room. Living room furniture includes one loveseat (two people), one side table and one entertainment console (where a wall-mounted television is not possible). Bedroom furniture includes one bed, one night stand and closet. Notwithstanding the above, it is acknowledged that residents have the ability to select furnishing and its placement to suit their accessibility needs.

ADAPTABLE FEATURE	PROVIDEI
A minimum of one bedroom shall be designed to meet the following criteria:  (i) accommodate a double bed (1345 mm x 1890 mm);  (ii) provide a clear turning radius of 1500 mm on one edge of the bed; and,  (iii)provide a clear open travel path of not less than 800 mm on the remaining sides of the bed (excluding the head).	
Where more than one bedroom is provided, each additional bedroom shall be designed to meet the following minimum criteria:  (i) accommodate a double bed; and,  (ii) provide a minimum clear open travel path of not less than 800 mm on the remaining sides of the bed (excluding the head).	
Controls and switches, including electrical, telephone, cable and data outlets hall be located between 455 mm and 1200 mm above the floor.	
Wiring for a visual alarm shall be tied into the fire alarm system for future installation of such alarm in the living room and bedroom(s).	

#### G. BALCONY

The following guidelines provide access to the balcony.

ADAPTABLE FEATURE	PROVIDED
A minimum clear width opening of 850 mm shall be provided to the balcony.	
The threshold shall be designed and constructed in a manner that is accessible, while maintaining the integrity of the building envelope. Alternatively, the accessibility of the balcony can be addressed with the provision of a portable wheelchair ramp.	

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**LEDINGHAM McALLISTER** 

Building BC since 1905

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NO.	DATE		
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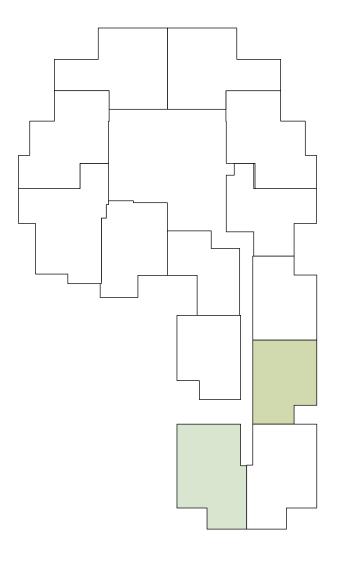
## THE BENNETT, **BURNABY, BC**

PROJECT NO: 116939 DRAWN BY: CHK'D BY: SCALE: DATE: 2019 AUGUST

## **ADAPTABLE MARKET UNITS**

SHEET NUMBER

SHEET TITLE





	ADAPTA	BLE UNITS	6	
LEVELS	1BD	2BD	3BD	TOTAL
6	1	1		2
5	1	1		2
4	1	1		2
3	1	1		2
2				0
1				0
TOTAL	4	4	0	8

## **TOTAL UNITS PROVIDED:**

4 2BDS 4 1BDS 8 UNITS

20% OF UNIT TOTAL

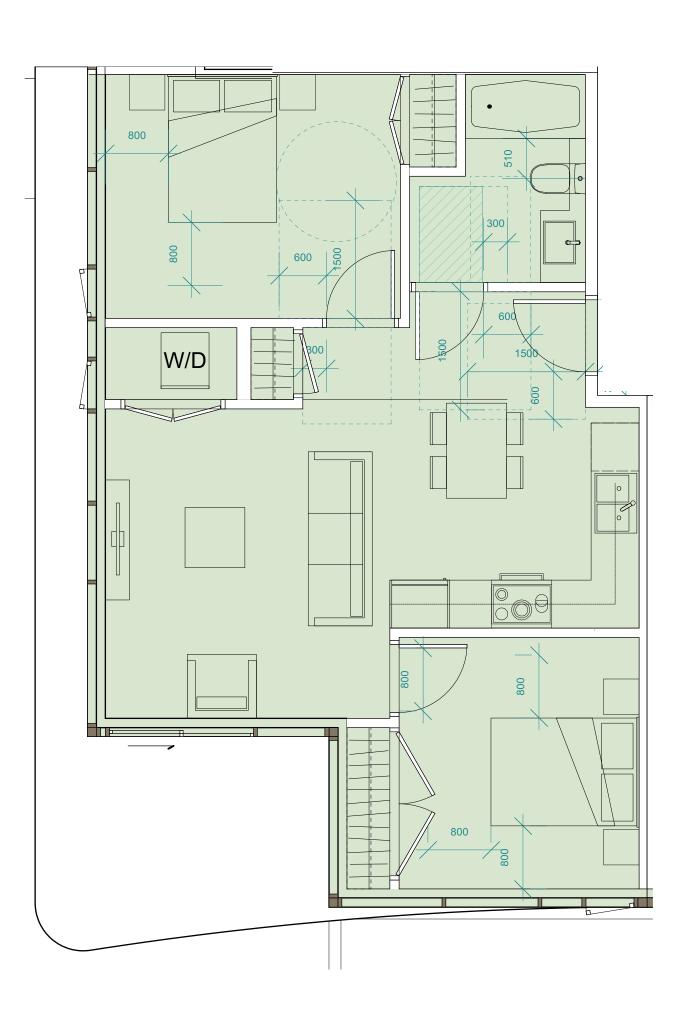

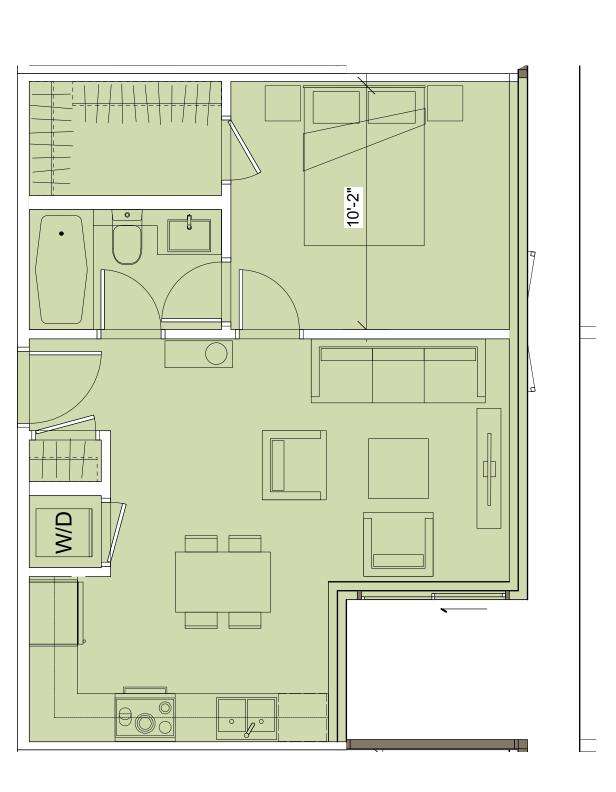

#### A. <u>BUILDING ENTRY AND CIRCULATION</u>

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PROVIDED

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**LEDINGHAM McALLISTER** Building BC since 1905

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NO.	DATE	APPR	

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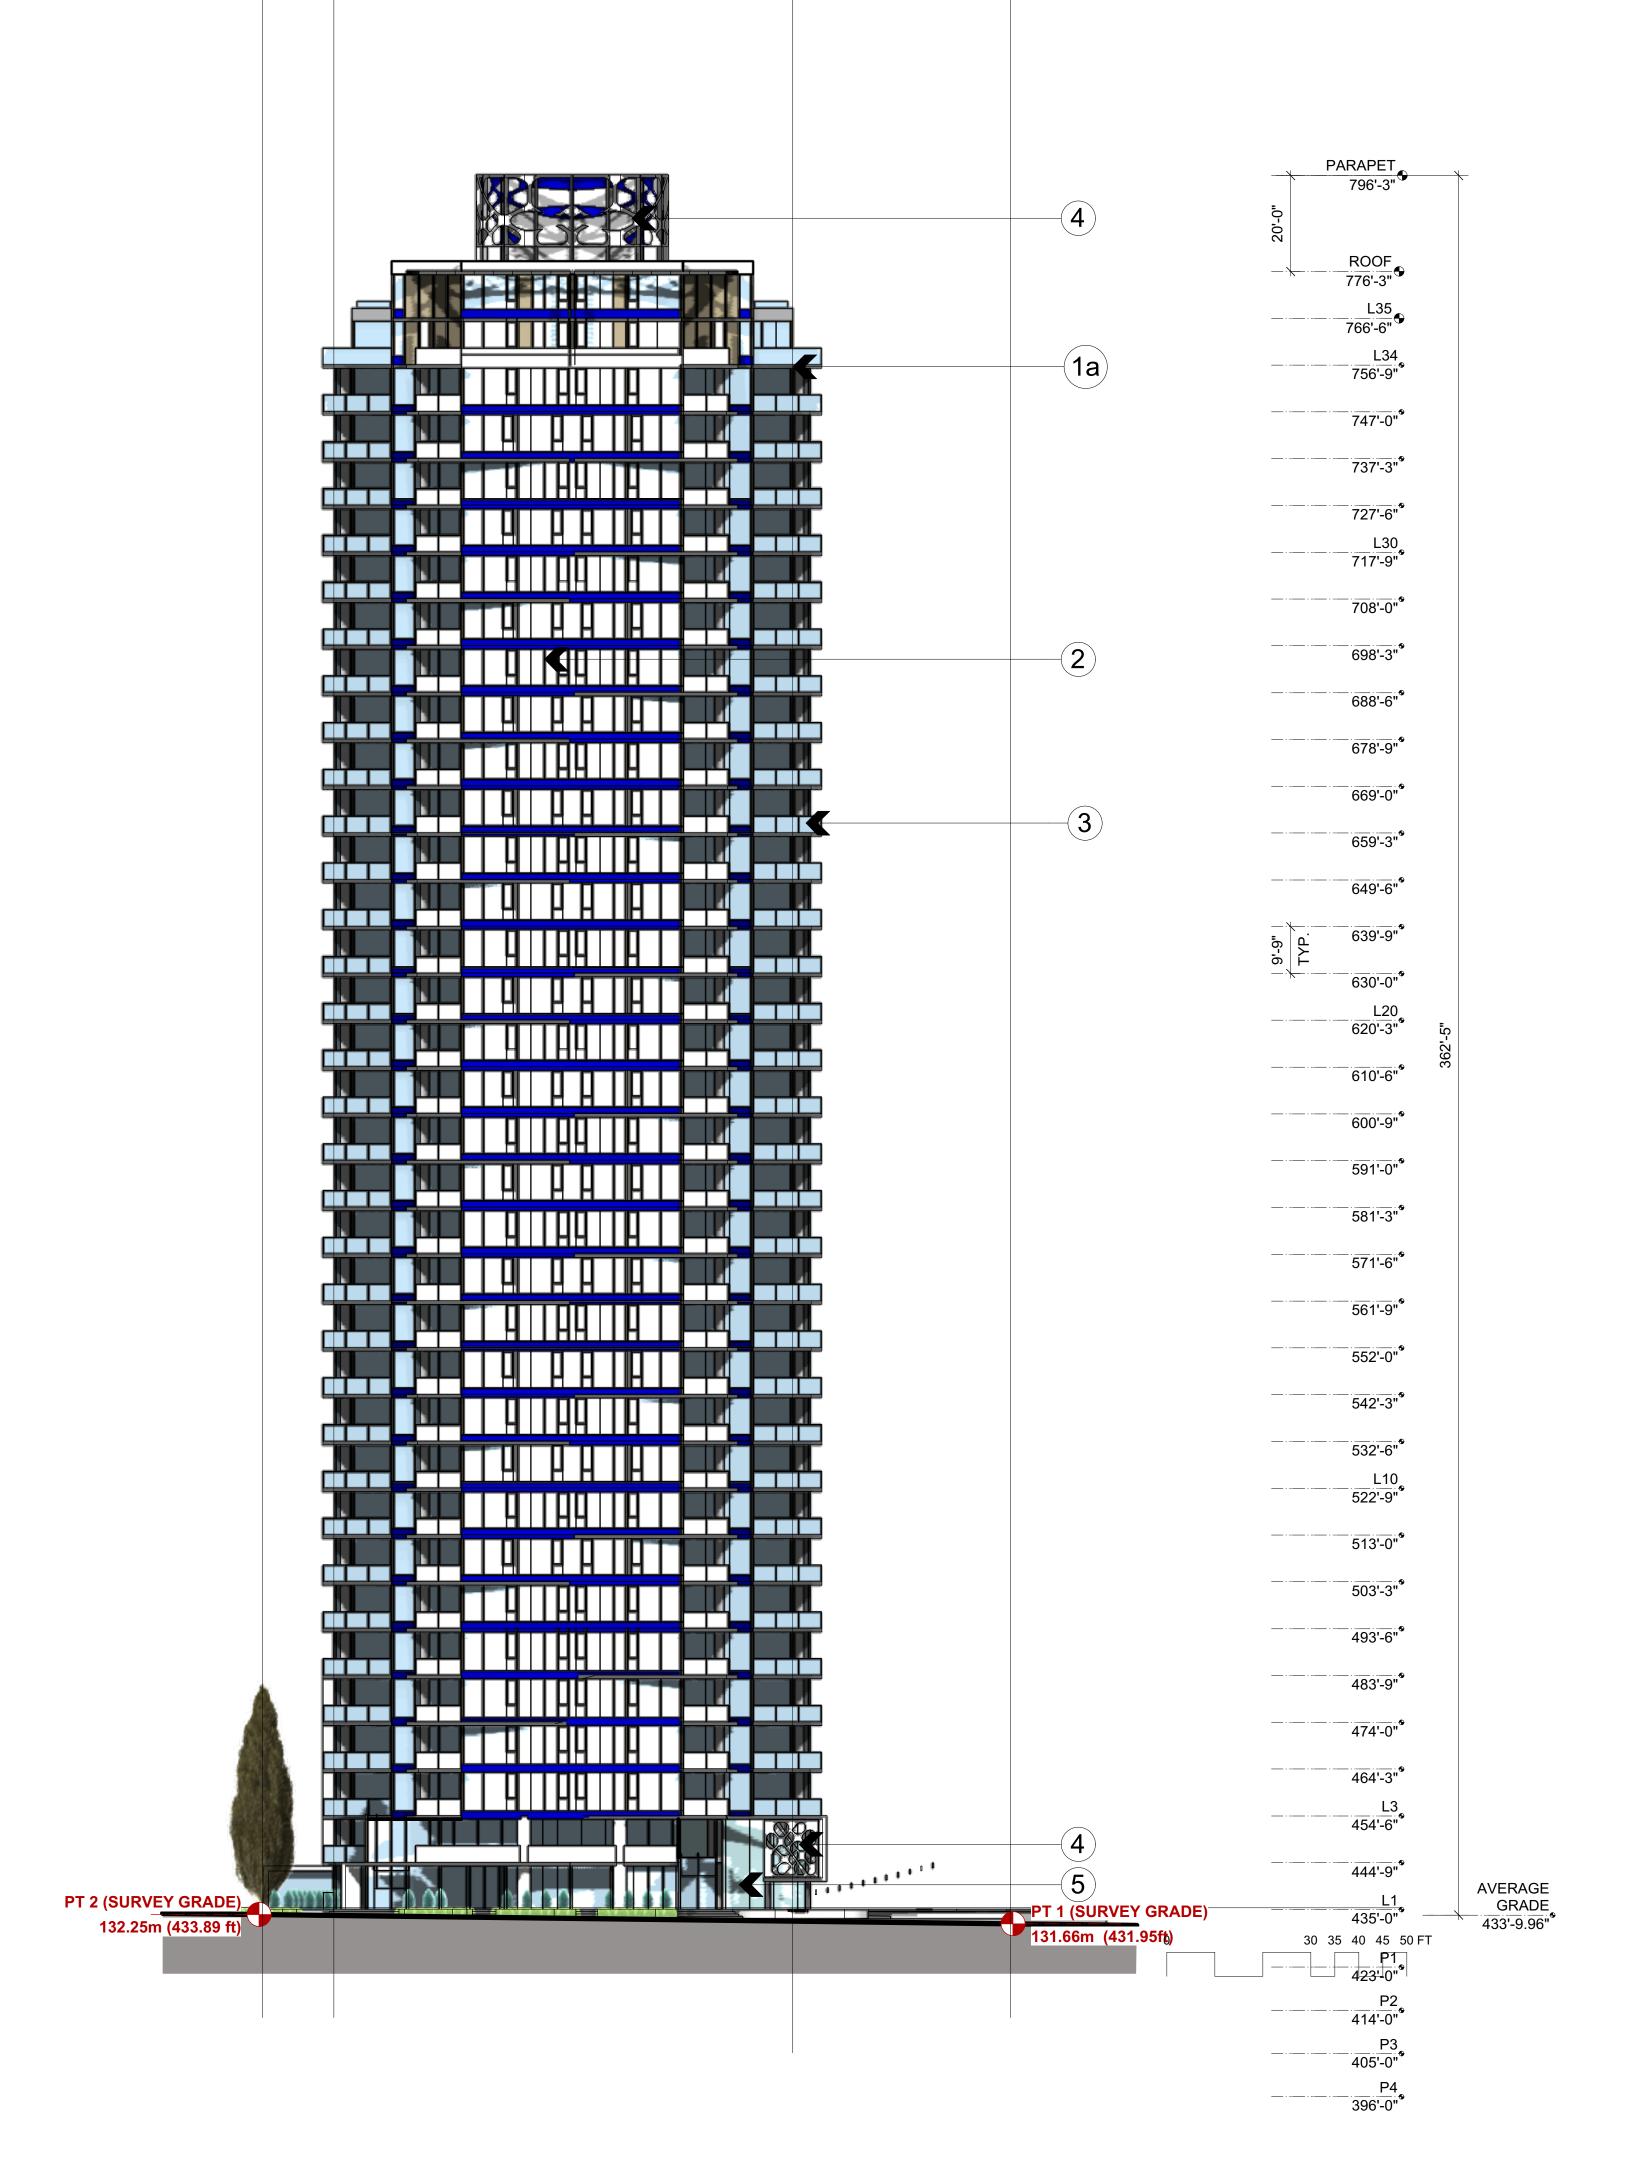
## THE BENNETT, **BURNABY, BC**


PROJECT NO: 116939 DRAWN BY: CHK'D BY: SCALE: DATE: 2019 AUGUST

## **ADAPTABLE RENTAL UNITS**

SHEET NUMBER

SHEET TITLE



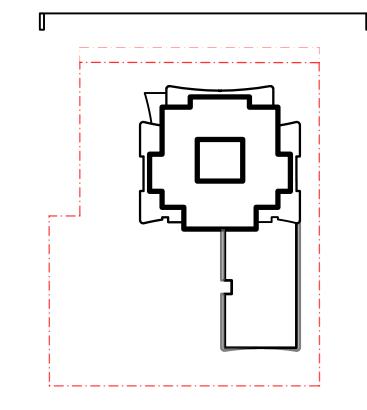

MATERIALS LIST

1) PAINTED CONCRETE

BENJAMIN MOORE 1a) "STONE WHITE" 2120-70" 1b) "NORMANDY" 2129-40 "

2) WINDOW WALL

ANODIZED ALUMINUM FRAMES BLUE GLASS SPANDREL LOW- E INSULATED GLASS UNITS

3) TOP MOUNTED GLASS BALCONY GUARDRAILS ANODIZED ALUMINUM FRAMING **CLEAR GLASS** 

4) DECORATIVE METAL SCREEN "ÁRTIC WHITE"

5) CURTAIN WALL SYSTEM LOW-E VISION GLASS

6) STEEL CORNICE ARTIC WHITE"

7) GLASS AND STELL ENTRY CANOPY C/W "SPIDER CONNECTORS"

ISSUES DESCRIPTION NO. DATE APPR REVISIONS

02 OCT 2019 ISSUED FOR REZONING

AUG 2019 DATE

ISSUED FOR REZONING

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PROJECT NO: 116939


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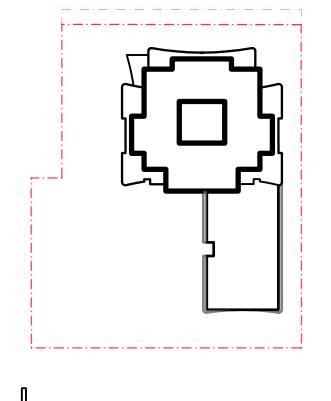
SCALE: 1/16" = 1'-0" DATE: 2019 AUGUST

SHEET TITLE

**NORTH** 

**ELEVATION** SHEET NUMBER



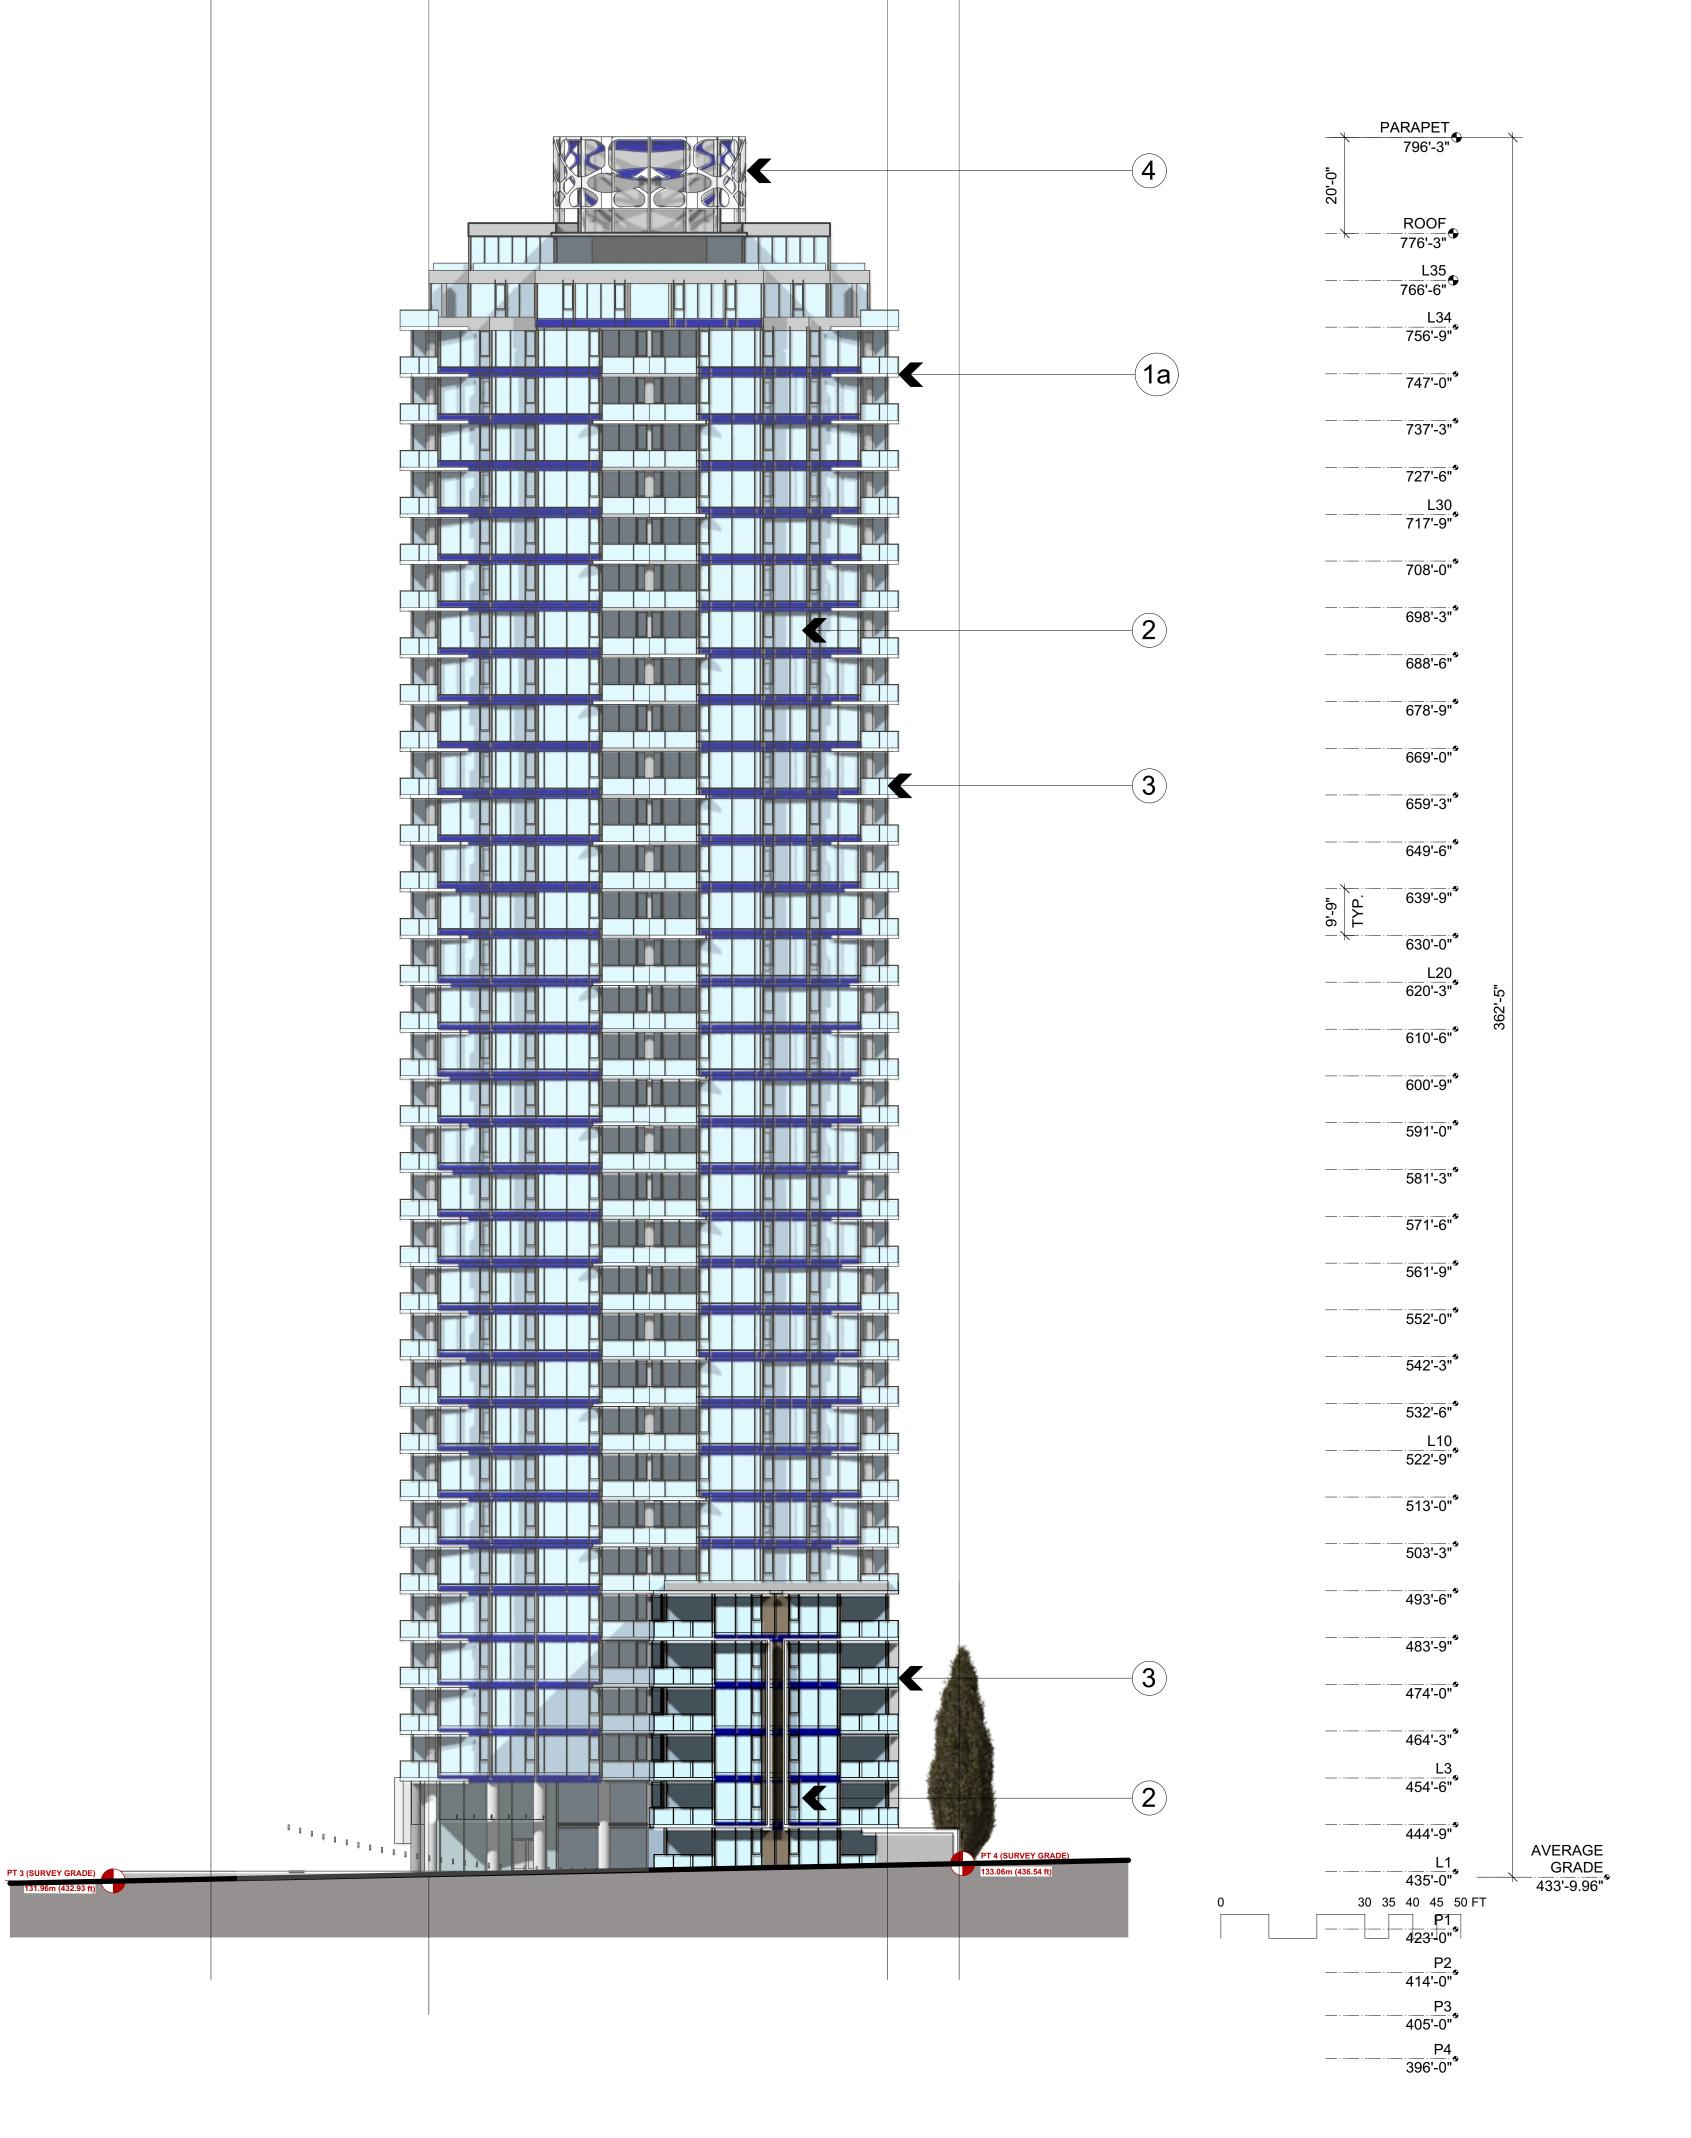

1) PAINTED CONCRETE

LOW- E INSULATED GLASS UNITS

3) TOP MOUNTED GLASS BALCONY GUARDRAILS ANODIZED ALUMINUM FRAMING **CLEAR GLASS** 

4) DECORATIVE METAL SCREEN "ÁRTIC WHITE"

5) CURTAIN WALL SYSTEM LOW-E VISION GLASS

6) STEEL CORNICE

C/W "SPIDER CONNECTORS"

MATERIALS LIST

BENJAMIN MOORE 1a) "STONE WHITE" 2120-70" 1b) "NORMANDY" 2129-40 "

2) WINDOW WALL

ANODIZED ALUMINUM FRAMES BLUE GLASS SPANDREL

ÁRTIC WHITE"

7) GLASS AND STELL ENTRY CANOPY

CLIENT



Building BC since 1905

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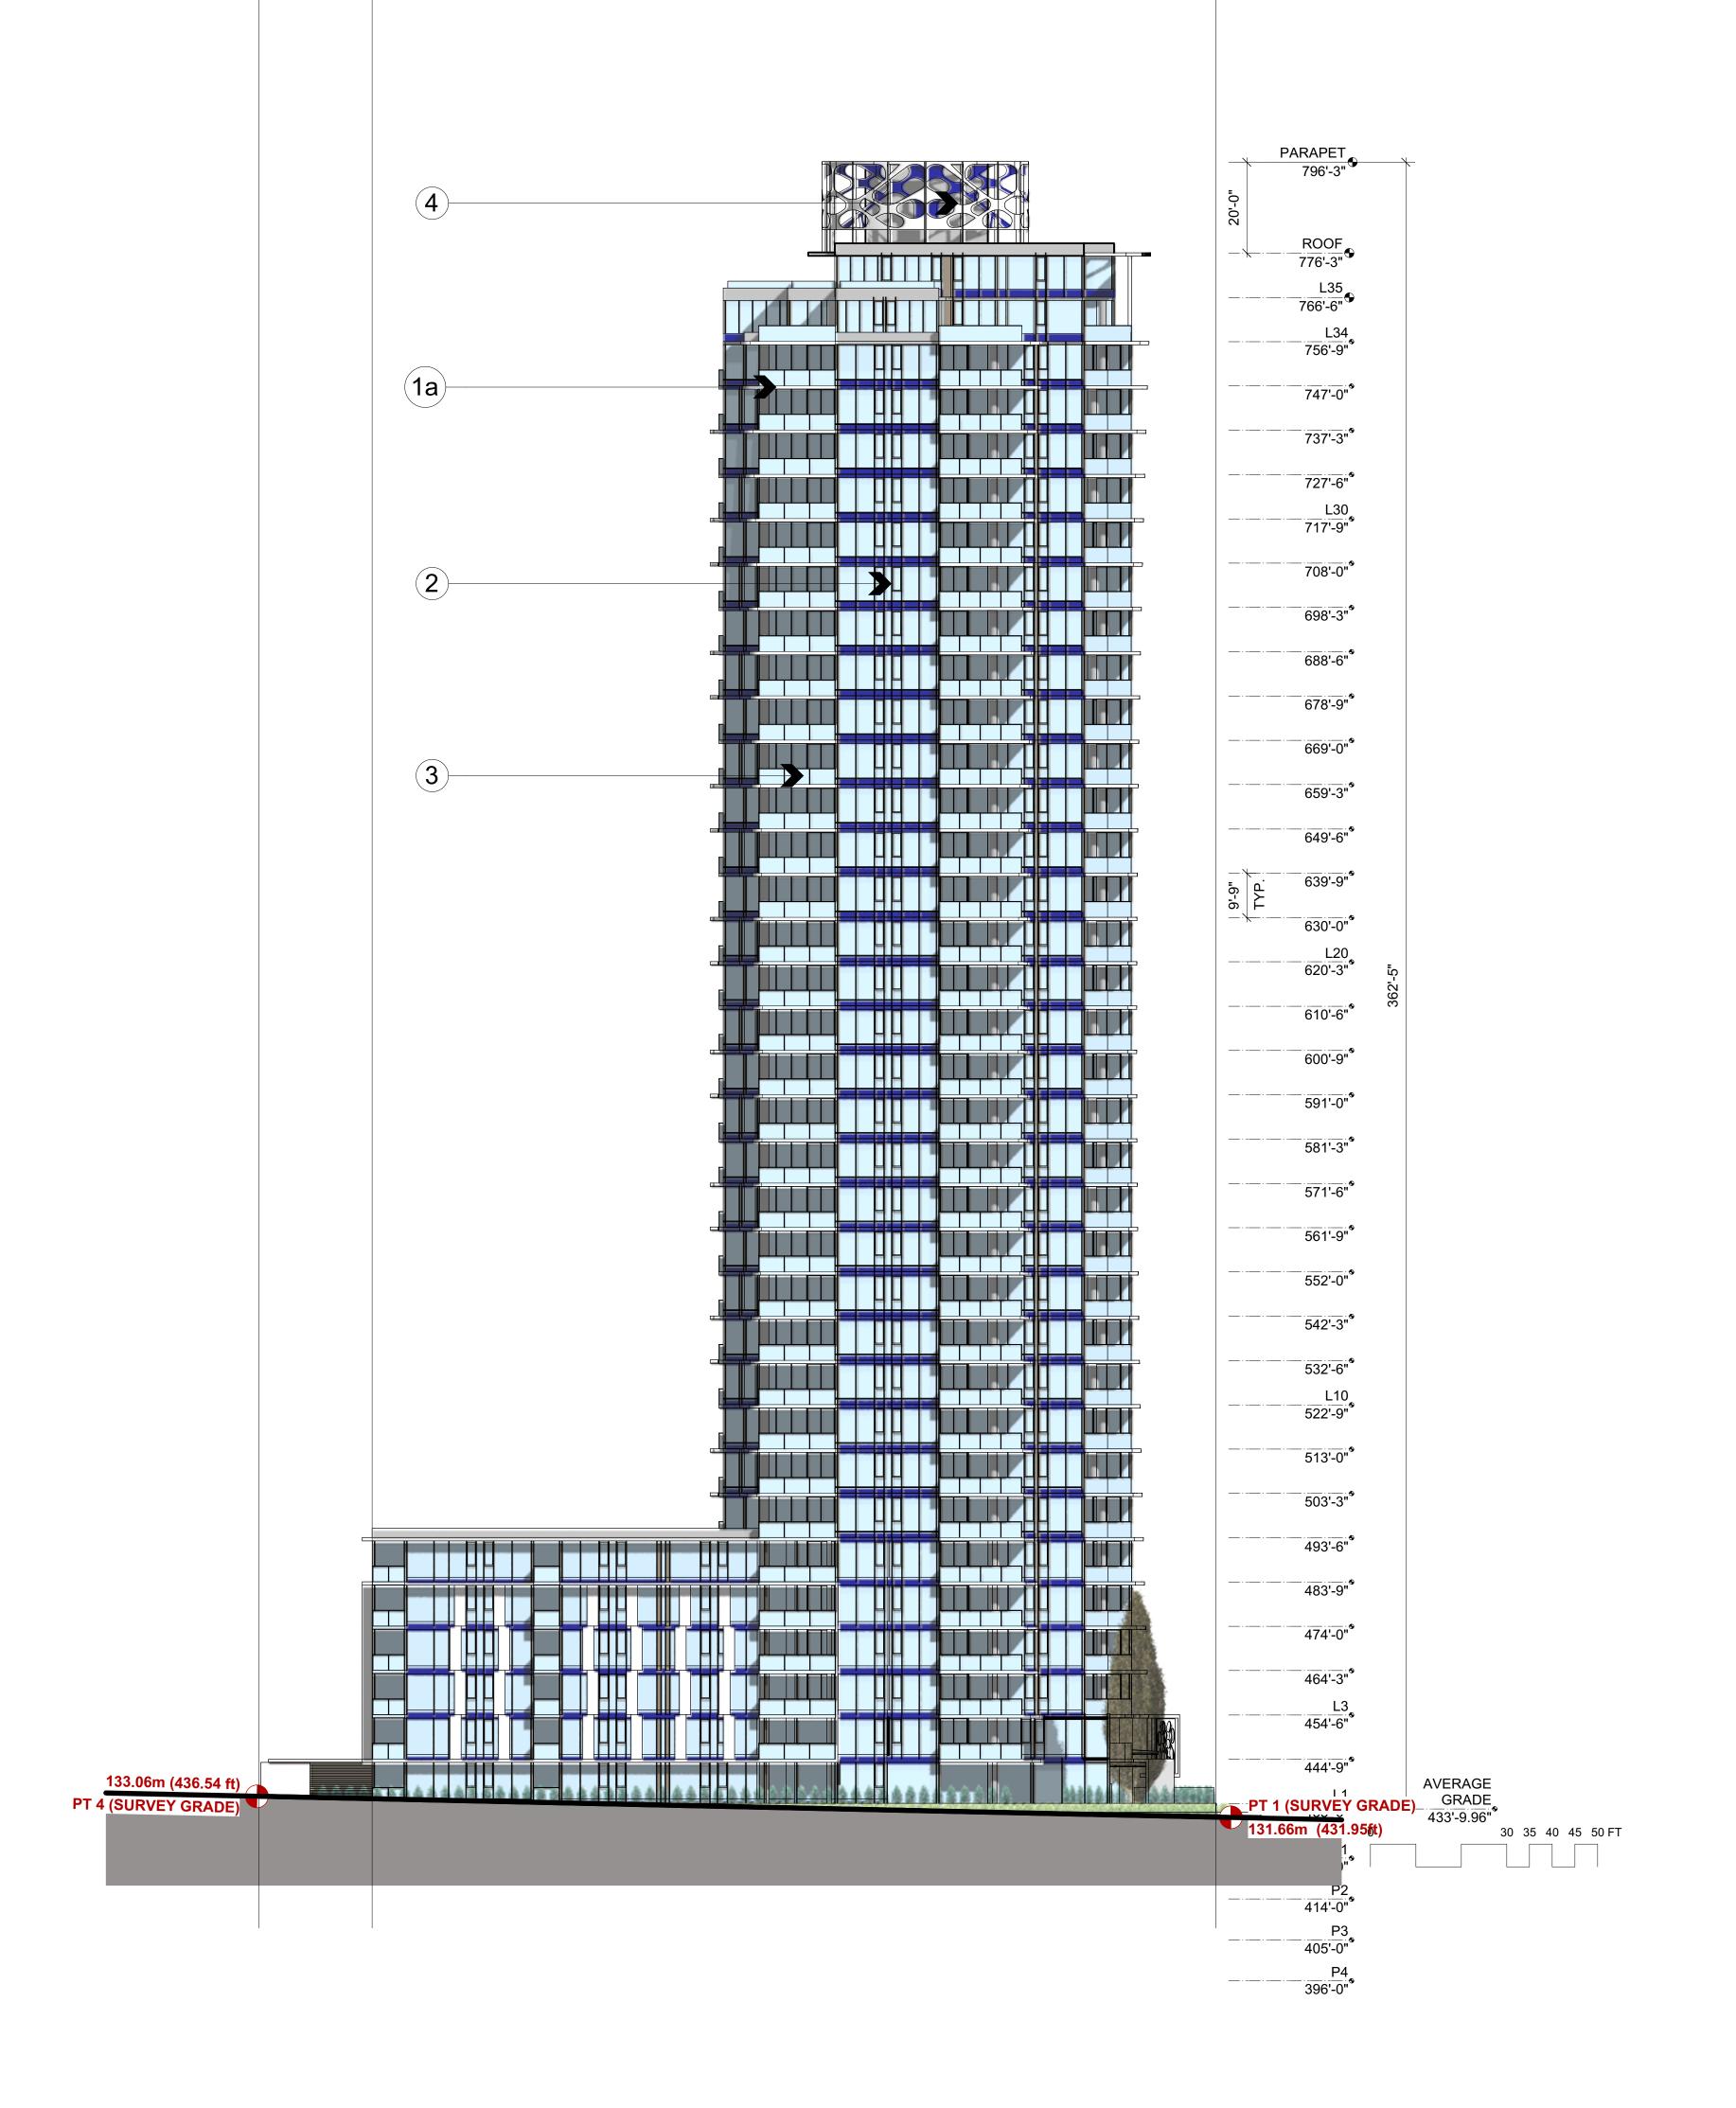
## THE BENNETT, **BURNABY**, **BC**


PROJECT NO: 116939 DRAWN BY: CHK'D BY: SCALE: 1/16" = 1'-0"

DATE: 2019 AUGUST SHEET TITLE

## SOUTH **ELEVATION**

SHEET NUMBER



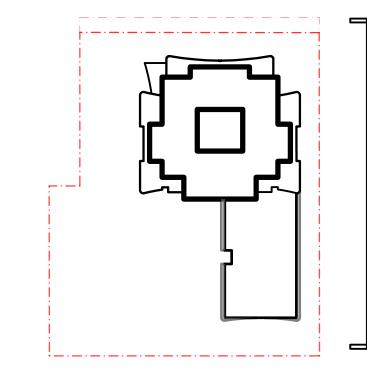

MATERIALS LIST

1) PAINTED CONCRETE

BENJAMIN MOORE 1a) "STONE WHITE" 2120-70" 1b) "NORMANDY" 2129-40 "

2) WINDOW WALL

ANODIZED ALUMINUM FRAMES BLUE GLASS SPANDREL LOW- E INSULATED GLASS UNITS

3) TOP MOUNTED GLASS BALCONY GUARDRAILS ANODIZED ALUMINUM FRAMING **CLEAR GLASS** 

4) DECORATIVE METAL SCREEN "ÁRTIC WHITE"

5) CURTAIN WALL SYSTEM LOW-E VISION GLASS

6) STEEL CORNICE ÁRTIC WHITE"

7) GLASS AND STELL ENTRY CANOPY C/W "SPIDER CONNECTORS"

LEDINGHAM McALLISTER Building BC since 1905

CLIENT

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IBI Group Architects (Canada) Inc.

02	OCT 2019	ISSI	JED FOR REZONING
01	AUG 2019	ISSI	JED FOR REZONING
NO.	DATE		
ISSUES			DESCRIPTION
NO.	DATE	APPR	
REVI	SIONS		

DESCRIPTION

SUB-CONSULTANT

PROJECT CONSULTANT



IBI GROUP
ARCHITECTS (CANADA) INC.
700 – 1285 West Pender Street
Vancouver BC V6E 4B1 Canada
tel 604 683 8797 fax 604 683 0492
ibigroup.com

## THE BENNETT, **BURNABY**, **BC**

PROJECT NO: 116939 DRAWN BY:


CHK'D BY: SCALE: 1/16" = 1'-0"


DATE: 2019 AUGUST

SHEET TITLE

### **EAST ELEVATION**

SHEET NUMBER

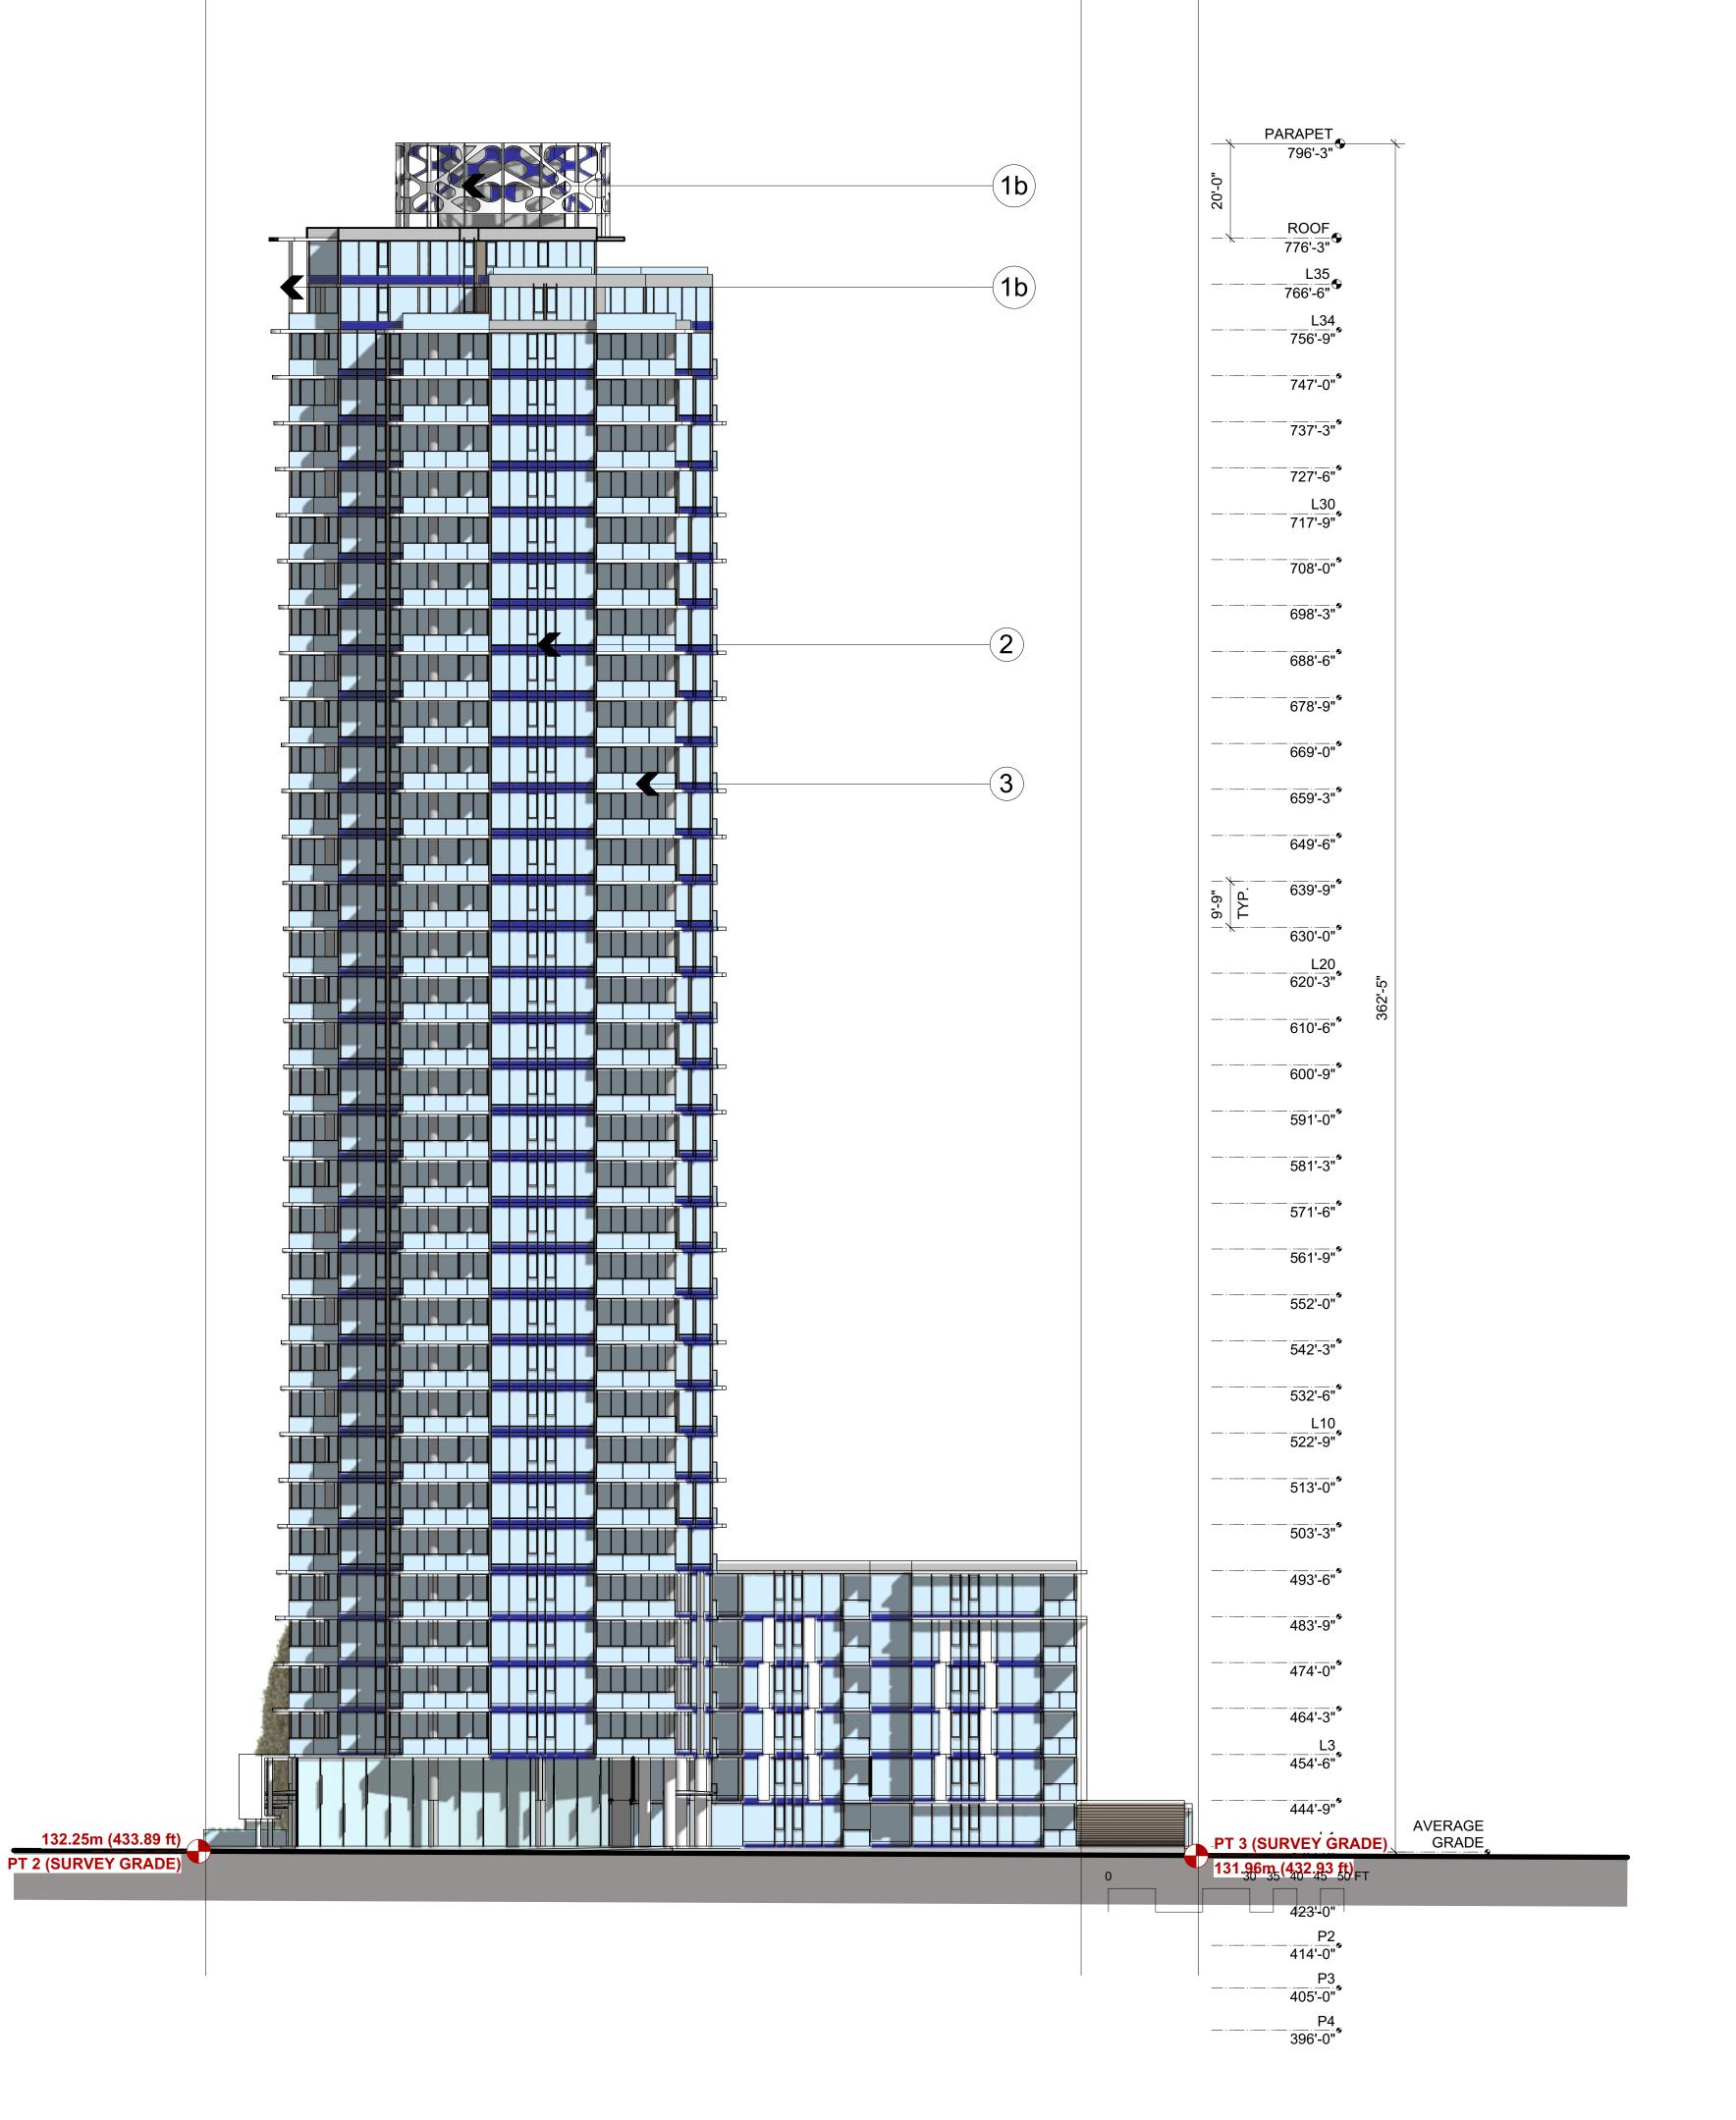

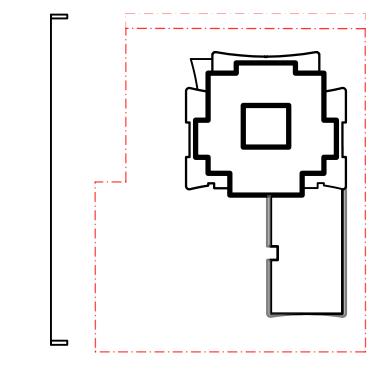

MATERIALS LIST

1) PAINTED CONCRETE

BENJAMIN MOORE 1a) "STONE WHITE" 2120-70" 1b) "NORMANDY" 2129-40 "

2) WINDOW WALL

ANODIZED ALUMINUM FRAMES BLUE GLASS SPANDREL LOW- E INSULATED GLASS UNITS

3) TOP MOUNTED GLASS BALCONY GUARDRAILS ANODIZED ALUMINUM FRAMING **CLEAR GLASS** 

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Vancouver BC V6E 4B1 Canada
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## PROJECT TITLE THE BENNETT, **BURNABY**, **BC**


PROJECT NO: 116939 DRAWN BY: CHK'D BY: SCALE: 1/16" = 1'-0"

SHEET TITLE

DATE: 2019 AUGUST

### **WEST ELEVATION**


SHEET NUMBER

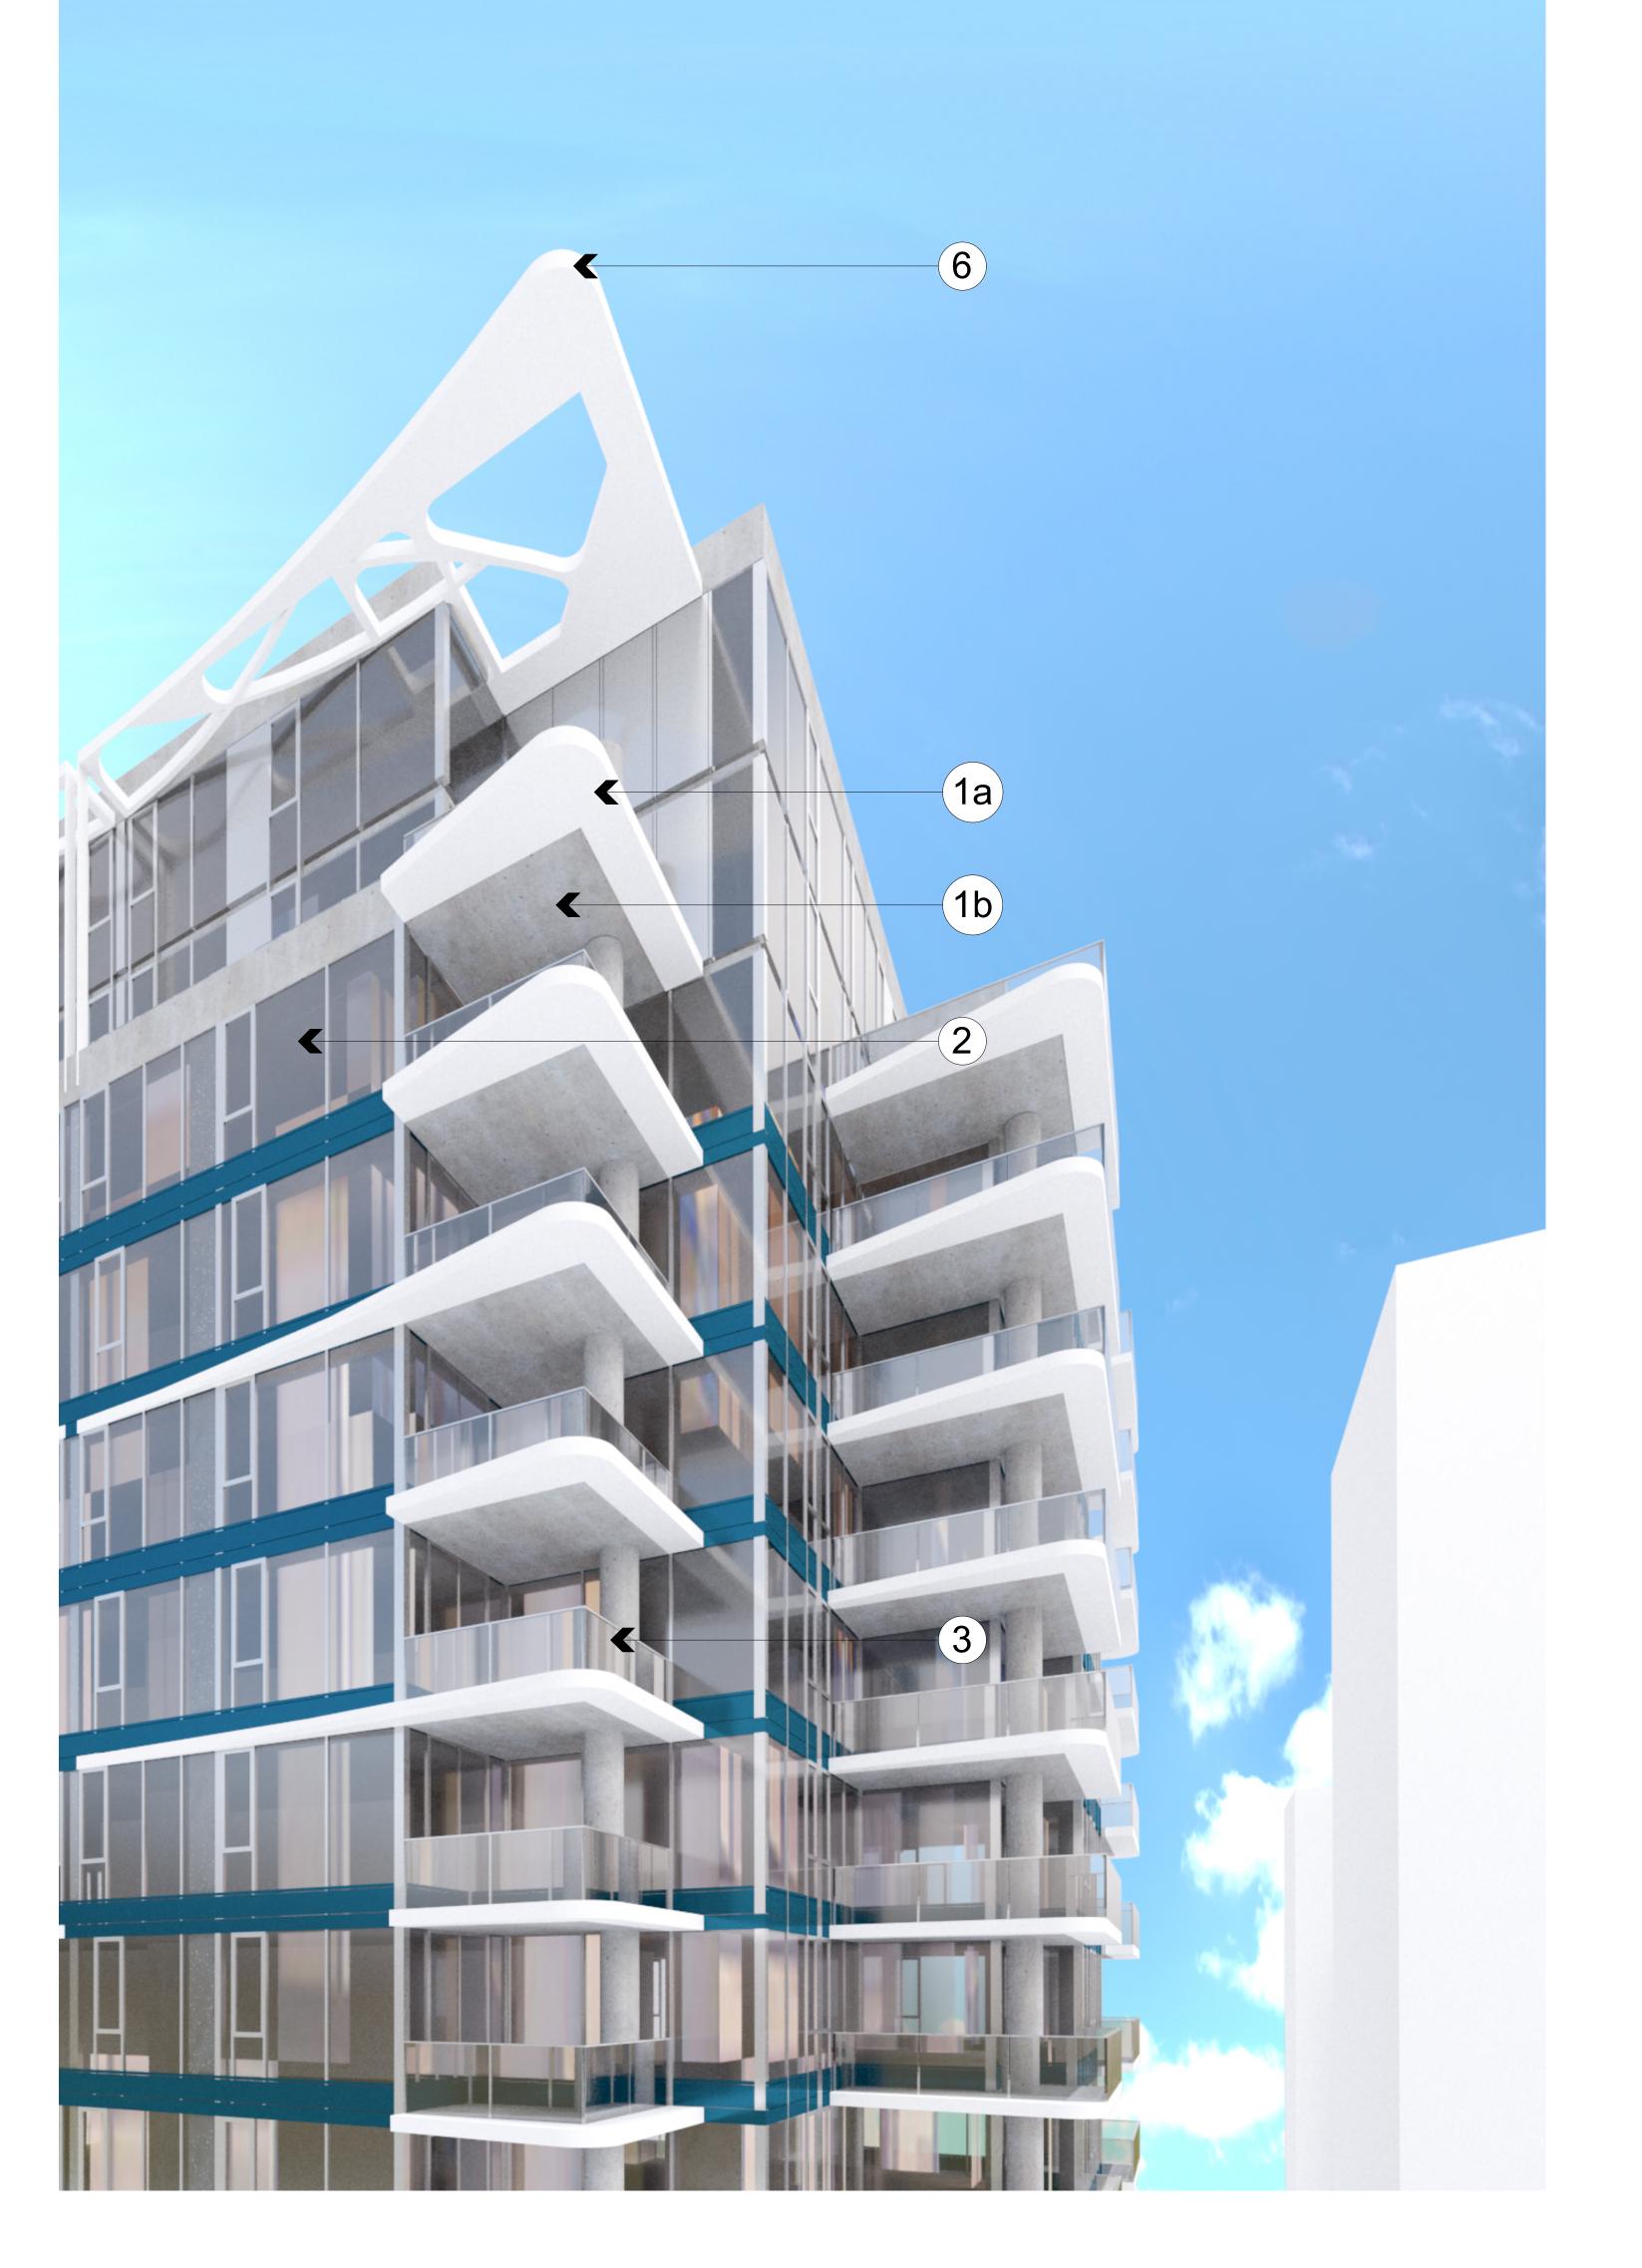



SPANDREL GLASS TO MATCH RGB 51,102,128



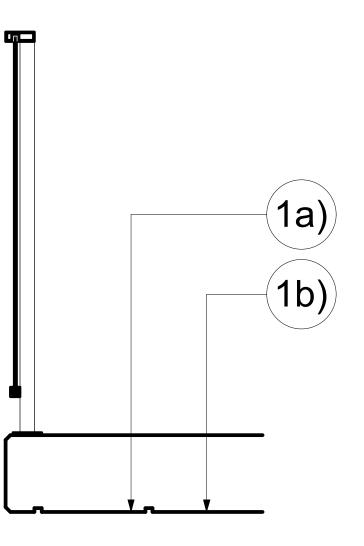

**GUARDRAIL DETAIL** 



MATERIALS LIST

1) PAINTED CONCRETE

BENJAMIN MOORE 1a) "STONE WHITE" 2120-70" 1b) "NORMANDY" 2129-40 "

2) WINDOW WALL

ANODIZED ALUMINUM FRAMES BLUE GLASS SPANDREL LOW- E INSULATED GLASS UNITS

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DESCRIPTION

REVISIONS

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## THE BENNETT, **BURNABY**, BC

PROJECT NO: 116939 DRAWN BY: CHK'D BY: SCALE: DATE: 2019 AUGUST

**MATERIALS** 

SHEET NUMBER

SHEET TITLE



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NO.	DATE		
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