

Roof Deck

Re-Issued for Suitable Pan of Development Re-Issued for Suitable Plan of Development 18-11-18 Issued for 3rd Reading 18-11-18 Issued for 3rd Reading Re-Issued for 3rd Reading Issued for Suitable Plan of Development Issued for Suitable Plan of Development V2

Issue / Revisions

Re-Issued for Suitable Plan of Development





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Design Consultant

INC.

Telford Ave. Multi-Residential 6525 Telford Ave. Burnaby, BC

Level 31 Floor Plan

Project Number 16046 3/32" = 1'-0"

Sheet Number PPA 11.7R1

Plan 26877



Issued for Suitable Plan of Development
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Plan 26877



Seal



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Design Consultant

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Telford Ave. Multi-Residential 6525 Telford Ave.
Burnaby, BC

Levels 32-37 Floor Plans


Project Number 16046

3/32" = 1'-0"
Sheet Number

PPA 11.8



Building the Extraordinary Issued for Suitable Plan of Development Issued for Suitable Plan of Development V2 **ARCHITECTS** 201-134 Abbott St Vancouver BC Canada V6B 2K4 T 604.669.1926 F 604.683.2241 info@nsda.bc.ca www.nsda.bc.ca Copyright Reserved. This plan and design is and at all times remains the exclusive property of NSDA Architects and cannot be used without the architects' written consent. Design Consultant
RICHARD HENRY ARCHITECT INC. Telford Ave. Multi-Residential 6525 Telford Ave. Burnaby, BC Roof Level Plan Project Number 16046 Scale 3/32" = 1'-0"

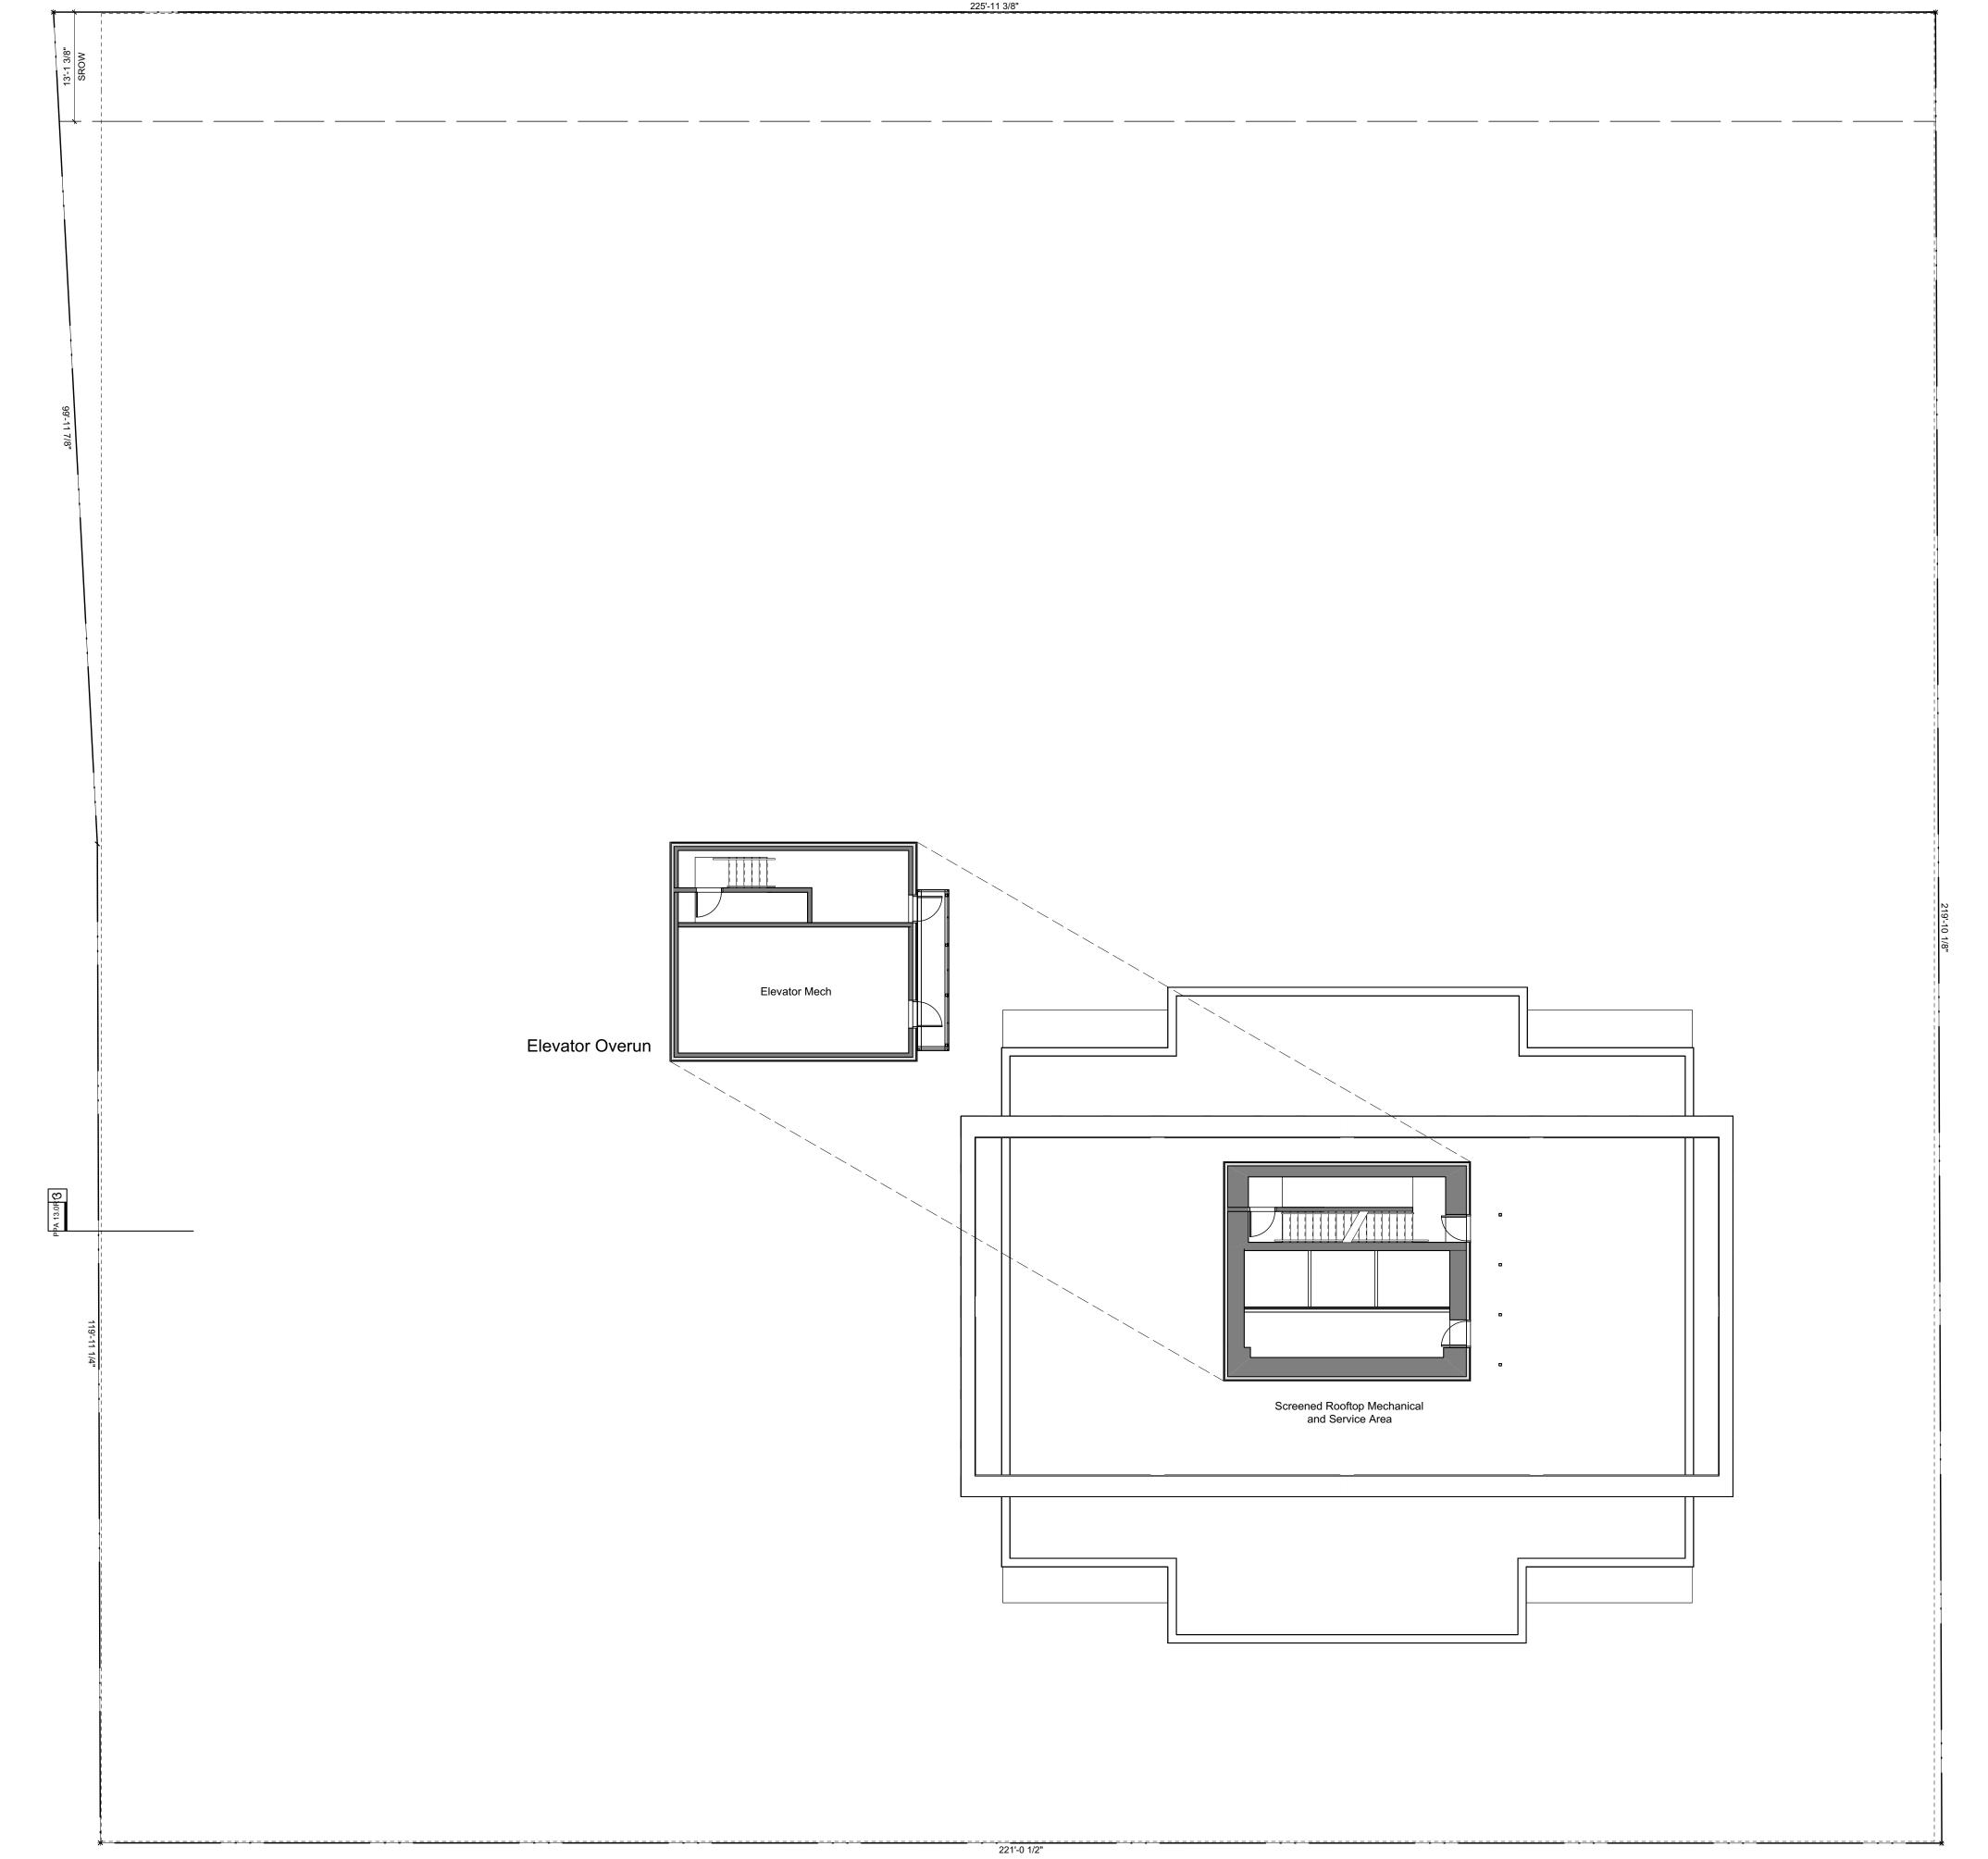



Plan 26877


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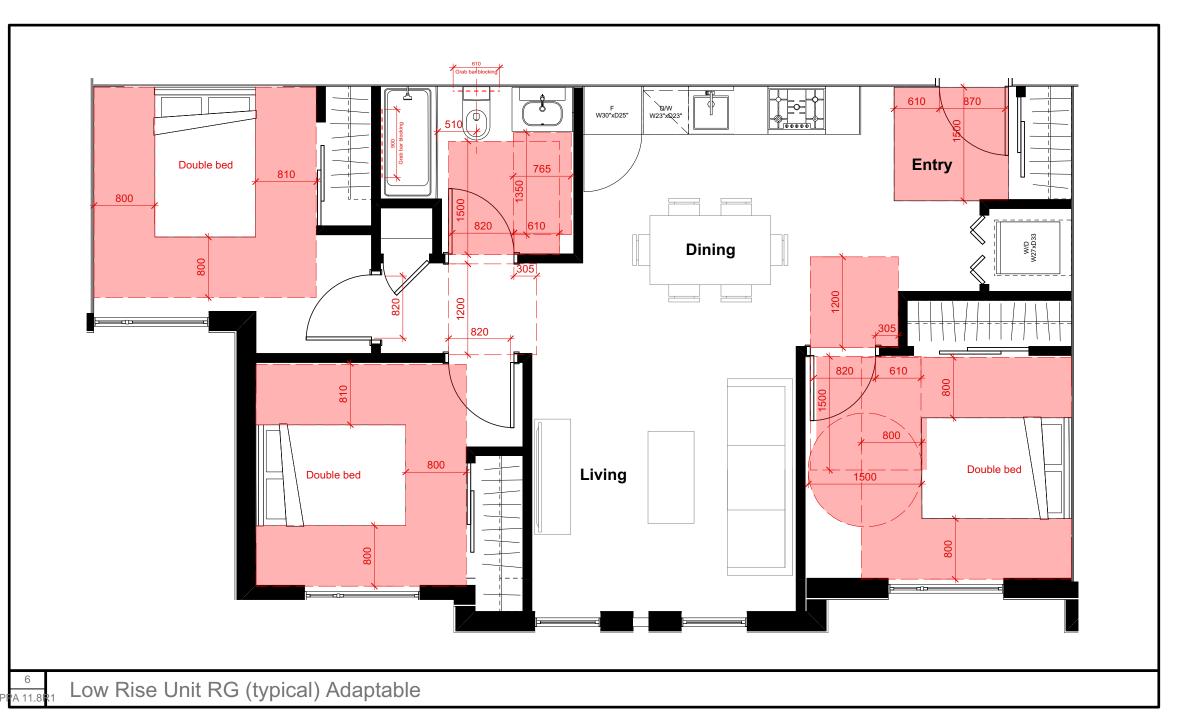
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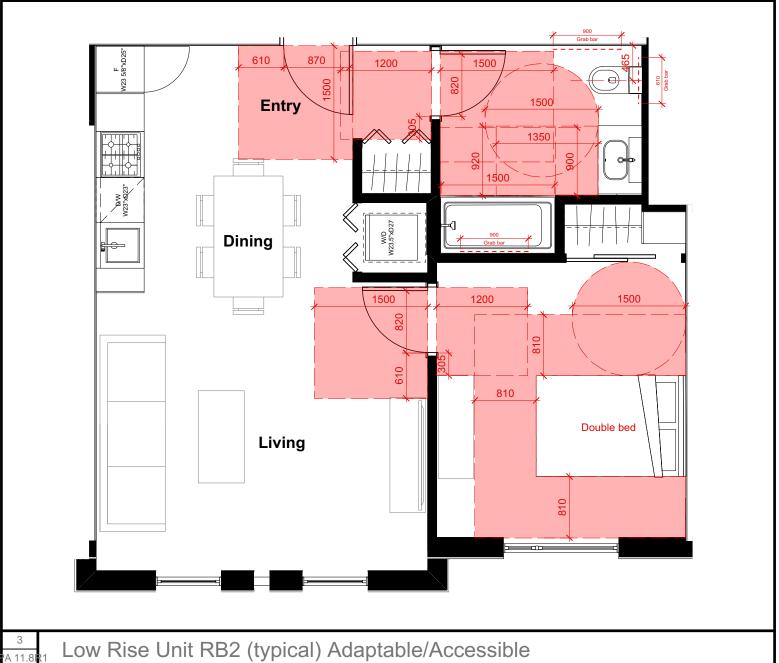






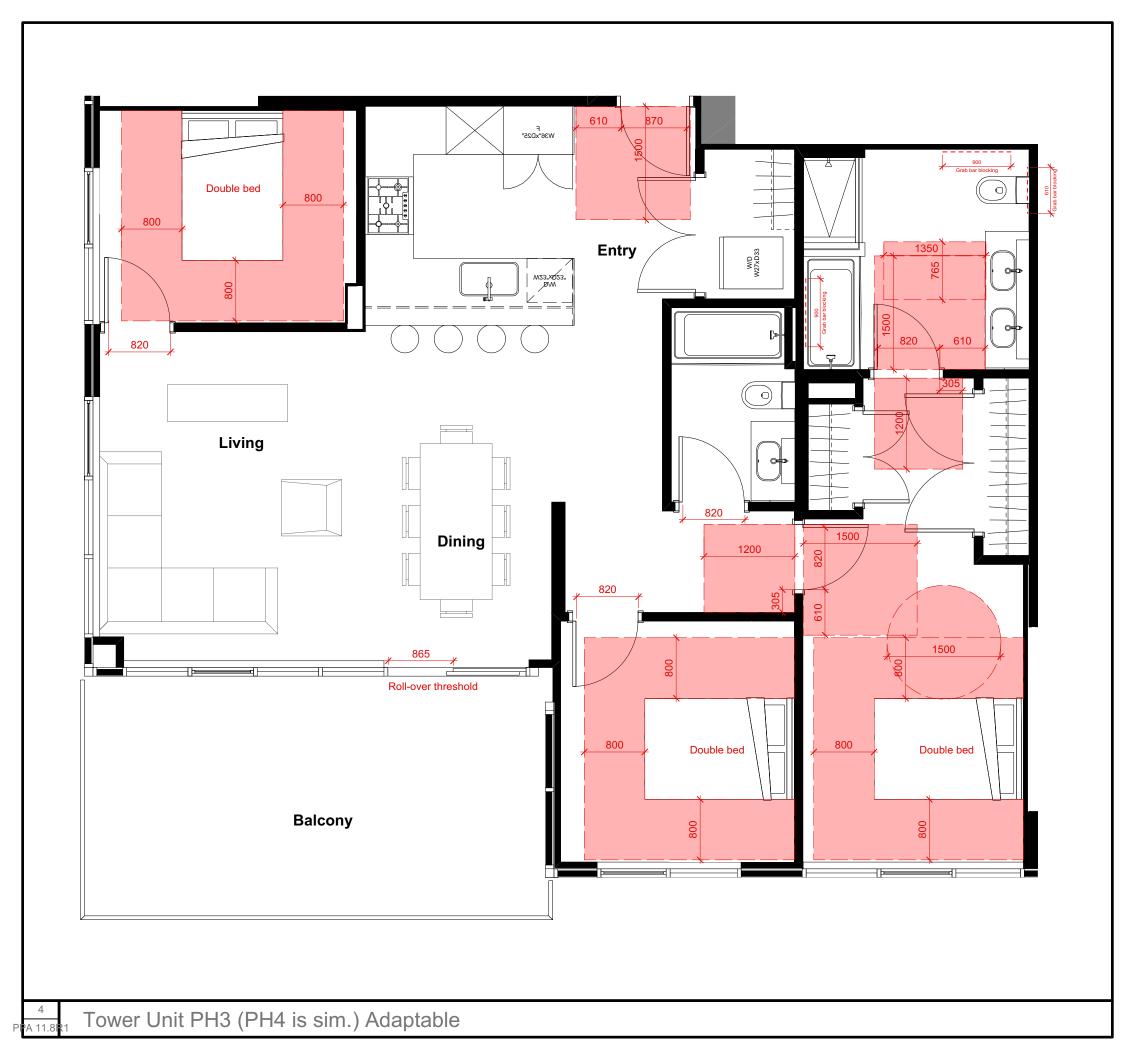

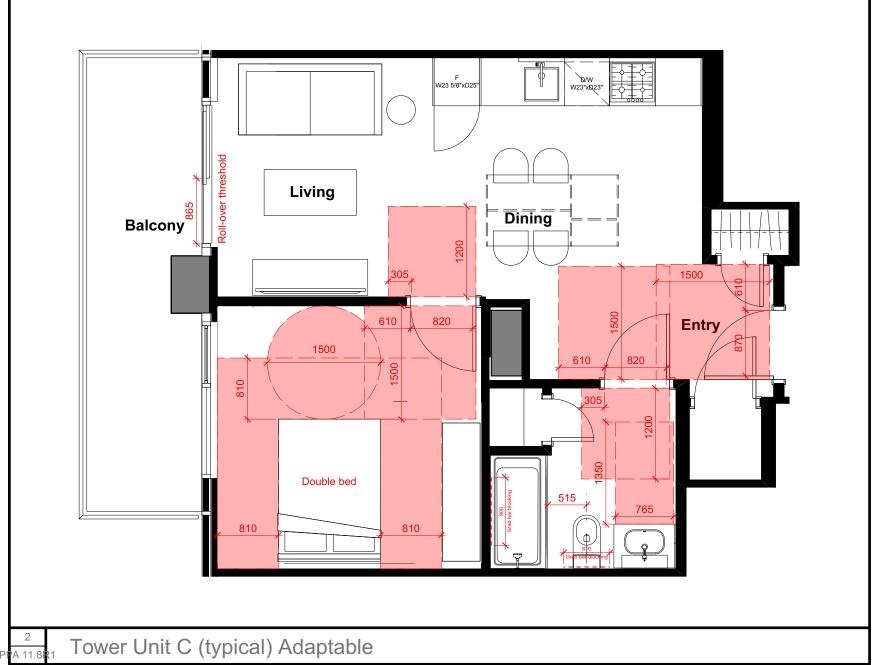

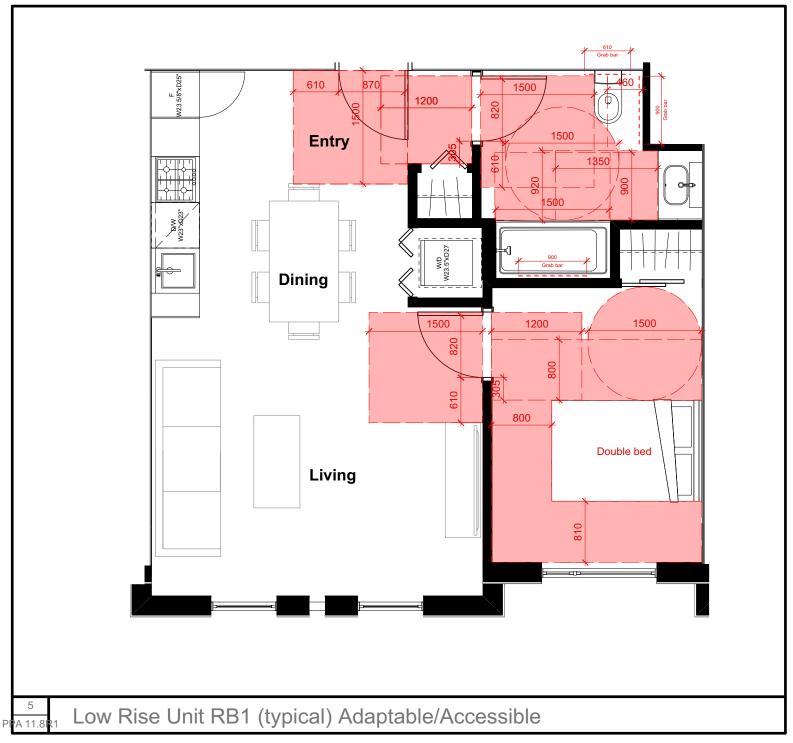

Note: All dimensions in metric this sheet only



Date Issue / Revisions
19-07-31 Issued for Suitable Plan of Development

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Telford Ave. Multi-Residential 6525 Telford Ave.
Burnaby, BC

Sheet Title
Unit Adaptability Compliance

Project Number 16046

Scale 1:50

Sheet Number
PPA 11.10

# ADAPTABLE DWELLING UNIT DESIGN GUIDELINES FOR MULTIPLE FAMILY RESIDENTIAL DEVELOPMENTS

(Updated 2019 July 05 - Updated Sketch)

Burnaby's *Adaptable Housing Policy* requires that a minimum of 20% of all single-level units in new multi-family and residential mixed-use developments, in which dwelling units are primarily accessed via a common corridor, be adaptable. The intent of the policy is to promote housing choice and flexibility such that people are able to meet their accessibility needs and age-in-place with minimal or no additional renovation costs in the future.

The construction requirements for adaptable dwelling units are specified in Subsection 3.8.5, Division B, of the BC Building Code. In addition to those requirements, the Planning Department, as part of the CD Comprehensive Development District rezoning process, reviews the design and configuration of adaptable dwelling units for:.

- the provision of adequate circulation and maneuvering space for wheelchairs or other mobility devices within the building / adaptable dwelling unit;
- the efficiency of the adentable dwelling unit's layout and configuration; and
- the efficiency of the adaptable dwelling unit's layout and configuration; and,
- the installation of equipment, controls, switches, outlets, and handles within the adaptable dwelling unit for ease, or reach and use.

Well-designed adaptable dwelling units meet basic accessibility such that people can comfortably move and operate within their own home.

The following *Adaptable Unit Design Guidelines* have been prepared to support developers and architects to meet the criteria used by the Planning Department to assess the design and configuration of adaptable dwelling units in each project. Architectural plans should clearly illustrate or note the accessible/adaptable features in each of the adaptable unit-types provided in the proposed CD development. *Attached* as a reference are illustrations of the accessible/adaptable features sought in adaptable dwelling units

#### **DEVELOPMENT STATISTICS**

D. <u>KITCHEN</u>

kitchen are to be within easy reach and use.

other or can have a continuous counter between them.

E. BATHROOM(S)/POWDER ROOM(S)

shall be located between 455 mm and 1200 mm above the floor.

ADAPTABLE FEATURE

meet their mobility needs.

ADAPTABLE FEATURE

future installation of grab bars.

pinching or twisting of the wrist.

The Burnaby Adaptable Housing policy requires that a minimum of 20% of all single-level units in new multi-family and residential mixed-use developments be adaptable. While no specific percentages are prescribed, the development should provide a balanced mix of adaptable dwelling units across the unit types within the development.

The following guidelines provide an efficient kitchen layout with basic clearance and maneuvering

space for a wheelchair or other mobility device. Equipment, controls, switches, and outlets within the

The following guidelines provide basic clearance and maneuvering space for a wheelchair or other

mobility device to access all bathroom(s) and/or powder room(s) within an adaptable dwelling unit.

Construction requirements to reinforce bathroom walls such that they are able to accommodate the

future installation of grab bars are a cost-savings to residents seeking to renovate the bathroom(s) to

A kitchen shall be designed such that the range and sink are adjacent to each

Controls and switches including electrical, telephone, cable and data outlets

A clear dimension of 800 mm from the front edge of the toilet to the

A minimum dimension of 510 mm shall be provided from the front face of

A minimum of one bathroom shall be designed with a clear floor area in

Walls adjacent to the toilet, bathtub or shower shall accommodate the

A clear floor space, exclusive of door swing, not less than 760 mm wide by

Controls and switches including electrical, telephone, cable and data outlets

Faucets shall be designed to be operable without tight grasping,

1350 mm deep connecting to the route through the doorway.

shall be located between 455 mm and 1200 mm above the floor.

facing wall, or edge of the tub if applicable, shall be provided.

front of the sink not less than 760 mm wide by 1350 mm deep.

the bathtub/shower to the centre line of the toilet.

PROVIDED

PROVIDED

Yes.

Yes.

Yes.

Yes.

Yes.

Yes.

Total number of dwelling units x 20% = 80 Total number of adaptable units required, which are distributed across the following unit types:

Studio units	One-Bedroom units
One-Bedroom + den units	Two-Bedroom units
$\times$ Two-Bedroom + den units	Three-Bedroom units or more

### FLOOR AREA EXEMPTION

#### **One Bedroom Units**

Adaptable dwelling units x  $1.86 \text{ m}^2$  of gross floor area =  $\frac{72.54}{\text{m}^2}$  excluded from the calculation of gross floor area.

#### **Two or more Bedroom Units**

<u>48</u> Adaptable dwelling units  $x = 1.86 \text{ m}^2 \text{ of gross floor area} + 0.93 \text{ m}^2 \text{ for every bedroom in excess}$ of the first adaptable bedroom = 89.28

#### A. BUILDING ENTRY AND CIRCULATION

The following guidelines allow for visitability to a residential development.

ADAPTABLE FEATURE	PROVIDED
<ul> <li>An accessible path of travel shall be provided:</li> <li>from the street, surface, passenger-loading zones and/or underground parking area to at least one main entrance;</li> <li>from the main entrance to each adaptable unit;</li> <li>from the main entrance to the elevator; and,</li> <li>from the main entrance to all common facilities or amenities (i.e. lounge, party room, pool/sauna, fitness room, guest suite, garbage/recycling).</li> </ul>	Yes.
Elevator entrances shall provide a clear area of not less than 1,500 mm x 1,500 mm on a floor where adaptable units or common facilities or amenities are located.	Yes.
Corridors and passage ways providing access to adaptable dwelling unit entrances and common facilities or amenities shall be not less than 1,220 mm in width.	Yes.
Door handles shall not require tight grasping or twisting of the wrist.	Yes.

# F. <u>LIVING ROOMS AND BEDROOM(S)</u>

The following guidelines provide basic clearance and maneuvering space for a wheelchair or other mobility device to access all living rooms and bedrooms within an adaptable dwelling unit. Areas identified on the architectural plans as living rooms and bedrooms should be illustrated with furniture to scale with the size and dimensions of the room. Living room furniture includes one loveseat (two people), one side table and one entertainment console (where a wall-mounted television is not possible). Bedroom furniture includes one bed, one night stand and closet. Notwithstanding the above, it is acknowledged that residents have the ability to select furnishing and its placement to suit their accessibility needs.

ADAPTABLE FEATURE	PROVIDED
A minimum of one bedroom shall be designed to meet the following criteria:  (i) accommodate a double bed (1345 mm x 1890 mm);  (ii) provide a clear turning radius of 1500 mm on one edge of the bed;	Yes.
and, (iii)provide a clear open travel path of not less than 800 mm on the remaining sides of the bed (excluding the head).	
Where more than one bedroom is provided, each additional bedroom shall be designed to meet the following minimum criteria:  (i) accommodate a double bed; and,  (ii) provide a minimum clear open travel path of not less than 800 mm on the remaining sides of the bed (excluding the head).	Yes.
Controls and switches, including electrical, telephone, cable and data outlets hall be located between 455 mm and 1200 mm above the floor.	Yes.
Viring for a visual alarm shall be tied into the fire alarm system for future	Yes.

## G. BALCONY

The following guidelines provide access to the balcony.

installation of such alarm in the living room and bedroom(s).

ADAPTABLE FEATURE	PROVIDED
A minimum clear width opening of 850 mm shall be provided to the balcony.	Yes.
The threshold shall be designed and constructed in a manner that is accessible, while maintaining the integrity of the building envelope. Alternatively, the accessibility of the balcony can be addressed with the provision of a portable wheelchair ramp.	Yes.

## B. <u>UNIT ENTRY</u>

The following guidelines provide basic clearance for a wheelchair or other mobility device to enter and exit an adaptable dwelling unit.

ADAPTABLE FEATURE	PROVIDED
Unit suite entry shall have a minimum clear opening of not less than 850 mm.	Yes.
<ul> <li>When the door swings out (away from the unit entry area), a minimum clearance of 1220 mm will be provided in the common corridor to accommodate the door swing movement. A 300 mm clear space beside the latching jamb of the door will also be provided.</li> <li>When the door swings in (towards the unit entranceway), a minimum clearance of 1500 mm will be provided in the entranceway to accommodate the door swing movement. A 600 mm clear space beside the latching jamb of the door will also be provided.</li> </ul>	Yes.
Door handles shall not require tight grasping or twisting of the wrist.	Yes.

#### C. INTERNAL DOORWAYS AND CORRIDORS (WITHIN ADAPTABLE UNIT)

The following guidelines provide basic clearance and maneuvering space for a wheelchair or other mobility device to access common living areas and rooms of an adaptable dwelling unit.

ADAPTABLE FEATURE	PROVIDED
All doorways providing access to all living areas within the unit shall have a clear minimum opening width of not less than 810 mm.	Yes.
<ul> <li>When the door swings out, a minimum clearance of 1220 mm will be provided in the corridor to accommodate the door swing movement. A 300 mm clear space beside the latching jamb of the door will also be provided.</li> <li>When the door swings in, a minimum clearance of 1500 mm will be provided in the entranceway to accommodate the door swing movement. A 600 mm clear space beside the latching jamb of the door will also be provided.</li> </ul>	Yes.
Internal unit corridors and passageways shall be a minimum of 850 mm in width.	Yes.
Door handles shall not require tight grasping or twisting of the wrist.	Yes.

# H. <u>PARKING</u>

The following guidelines relate to the provision of accessible parking stalls.

ADAPTABLE FEATURE	PROVIDED
Parking stalls shall be 3.7 m in width, including 1200 mm for entering and leaving the vehicle	Yes.
Parking stalls shall be located as close as possible to an accessible main entry (surface) or elevator (underground).	Yes.
Parking stalls shall be marked as disabled parking in compliance with the Motor Vehicle Act.	Yes.

# RECOMMENDED DISABLED PARKING STALLS PER DEVELOPMENT

TOTAL NUMBER OF PARKING SPACES	REQUIRED DISABLED PARKING SPACES
1 – 25	1
26 – 50	2
51 – 100	3
101 – 150	4
151 – 200	5
201 – 250	6
251 – 300	7
301 – 350	8
351 – 400	9
401 – 450	10

P:\Housing\Adaptable Housing\Guidelines



Issue / Revisions
Issued for Suitable Plan of Development V2

Seal



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Telford Ave. Multi-Residential 6525 Telford Ave.
Burnaby, BC

Sheet Title
Adaptability Checklist

Project Number 16046

Scale 1:50

PPA 11.11





Date 17-11-27	Issue / Revisions Issued for Suitable Plan of Development
18-1-30	Re-Issued for Suitable Plan of Developmen
18-6-22	Re-Issued for Suitable Plan of Developmen
18-11-18	Issued for 3rd Reading
18-3-27	Re-Issued for Suitable Plan of Developmen
19-1-14	Re-Issued for 3rd Reading
19-1-14	Re-Issued for 3rd Reading
19-07-31	Issued for Suitable Plan of Development
19-08-29	Issued for Suitable Plan of Development V2

# Materials Legend

- (A1) Painted Concrete
- A2 Clear Sealed Concrete
- Clay brick masonry and mortar
- Cementitious fibreboard panel
- C3)
- (C4) High pressure laminate panel
- Painted Metal fences, canopies,
- louvres, exterior doors and frames, guardrails, privacy screen frames, window system frames, metal
- panels, louvres, screens and,
- grilles, vinyl windows
- Opaque Window System spandrel panels
- Tinted Glazing at windows, guardrails, canopies
- Clear Glazing at windows, guardrails, canopies
- (E4) Translucent Glazing at guardrails, privacy screens
- Painted wood grain aluminum extrusions

Seal



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Telford Ave. Multi-Residential 6525 Telford Ave. Burnaby, BC

Sheet Title

East & North Elevations

Project Number 16046

Scale 1" = 20'-0"

PPA 12.0R1





Date	Issue / Revisions
17-11-27	Issued for Suitable Plan of Development
18-1-30	Re-Issued for Suitable Plan of Development
18-6-22	Re-Issued for Suitable Plan of Development
18-11-18	Issued for 3rd Reading
18-3-27	Re-Issued for Suitable Plan of Development
19-1-14	Re-Issued for 3rd Reading
19-1-14	Re-Issued for 3rd Reading
19-07-31	Issued for Suitable Plan of Development
19-08-29	Issued for Suitable Plan of Development V2

# Materials Legend

- Painted Concrete
- A2 Clear Sealed Concrete
- Clay brick masonry and mortar
- Cementitious fibreboard panel
- )
- High pressure laminate panel
- Painted Metal fences, canopies,
- louvres, exterior doors and frames, guardrails, privacy screen frames, window system frames, metal
- panels, louvres, screens and,
- grilles, vinyl windows

  Opaque Window System spandrel panels
- Tinted Glazing at windows,
- guardrails, canopies
- Clear Glazing at windows, guardrails, canopies
- (E4) Translucent Glazing at guardrails, privacy screens
- Painted wood grain aluminum extrusions



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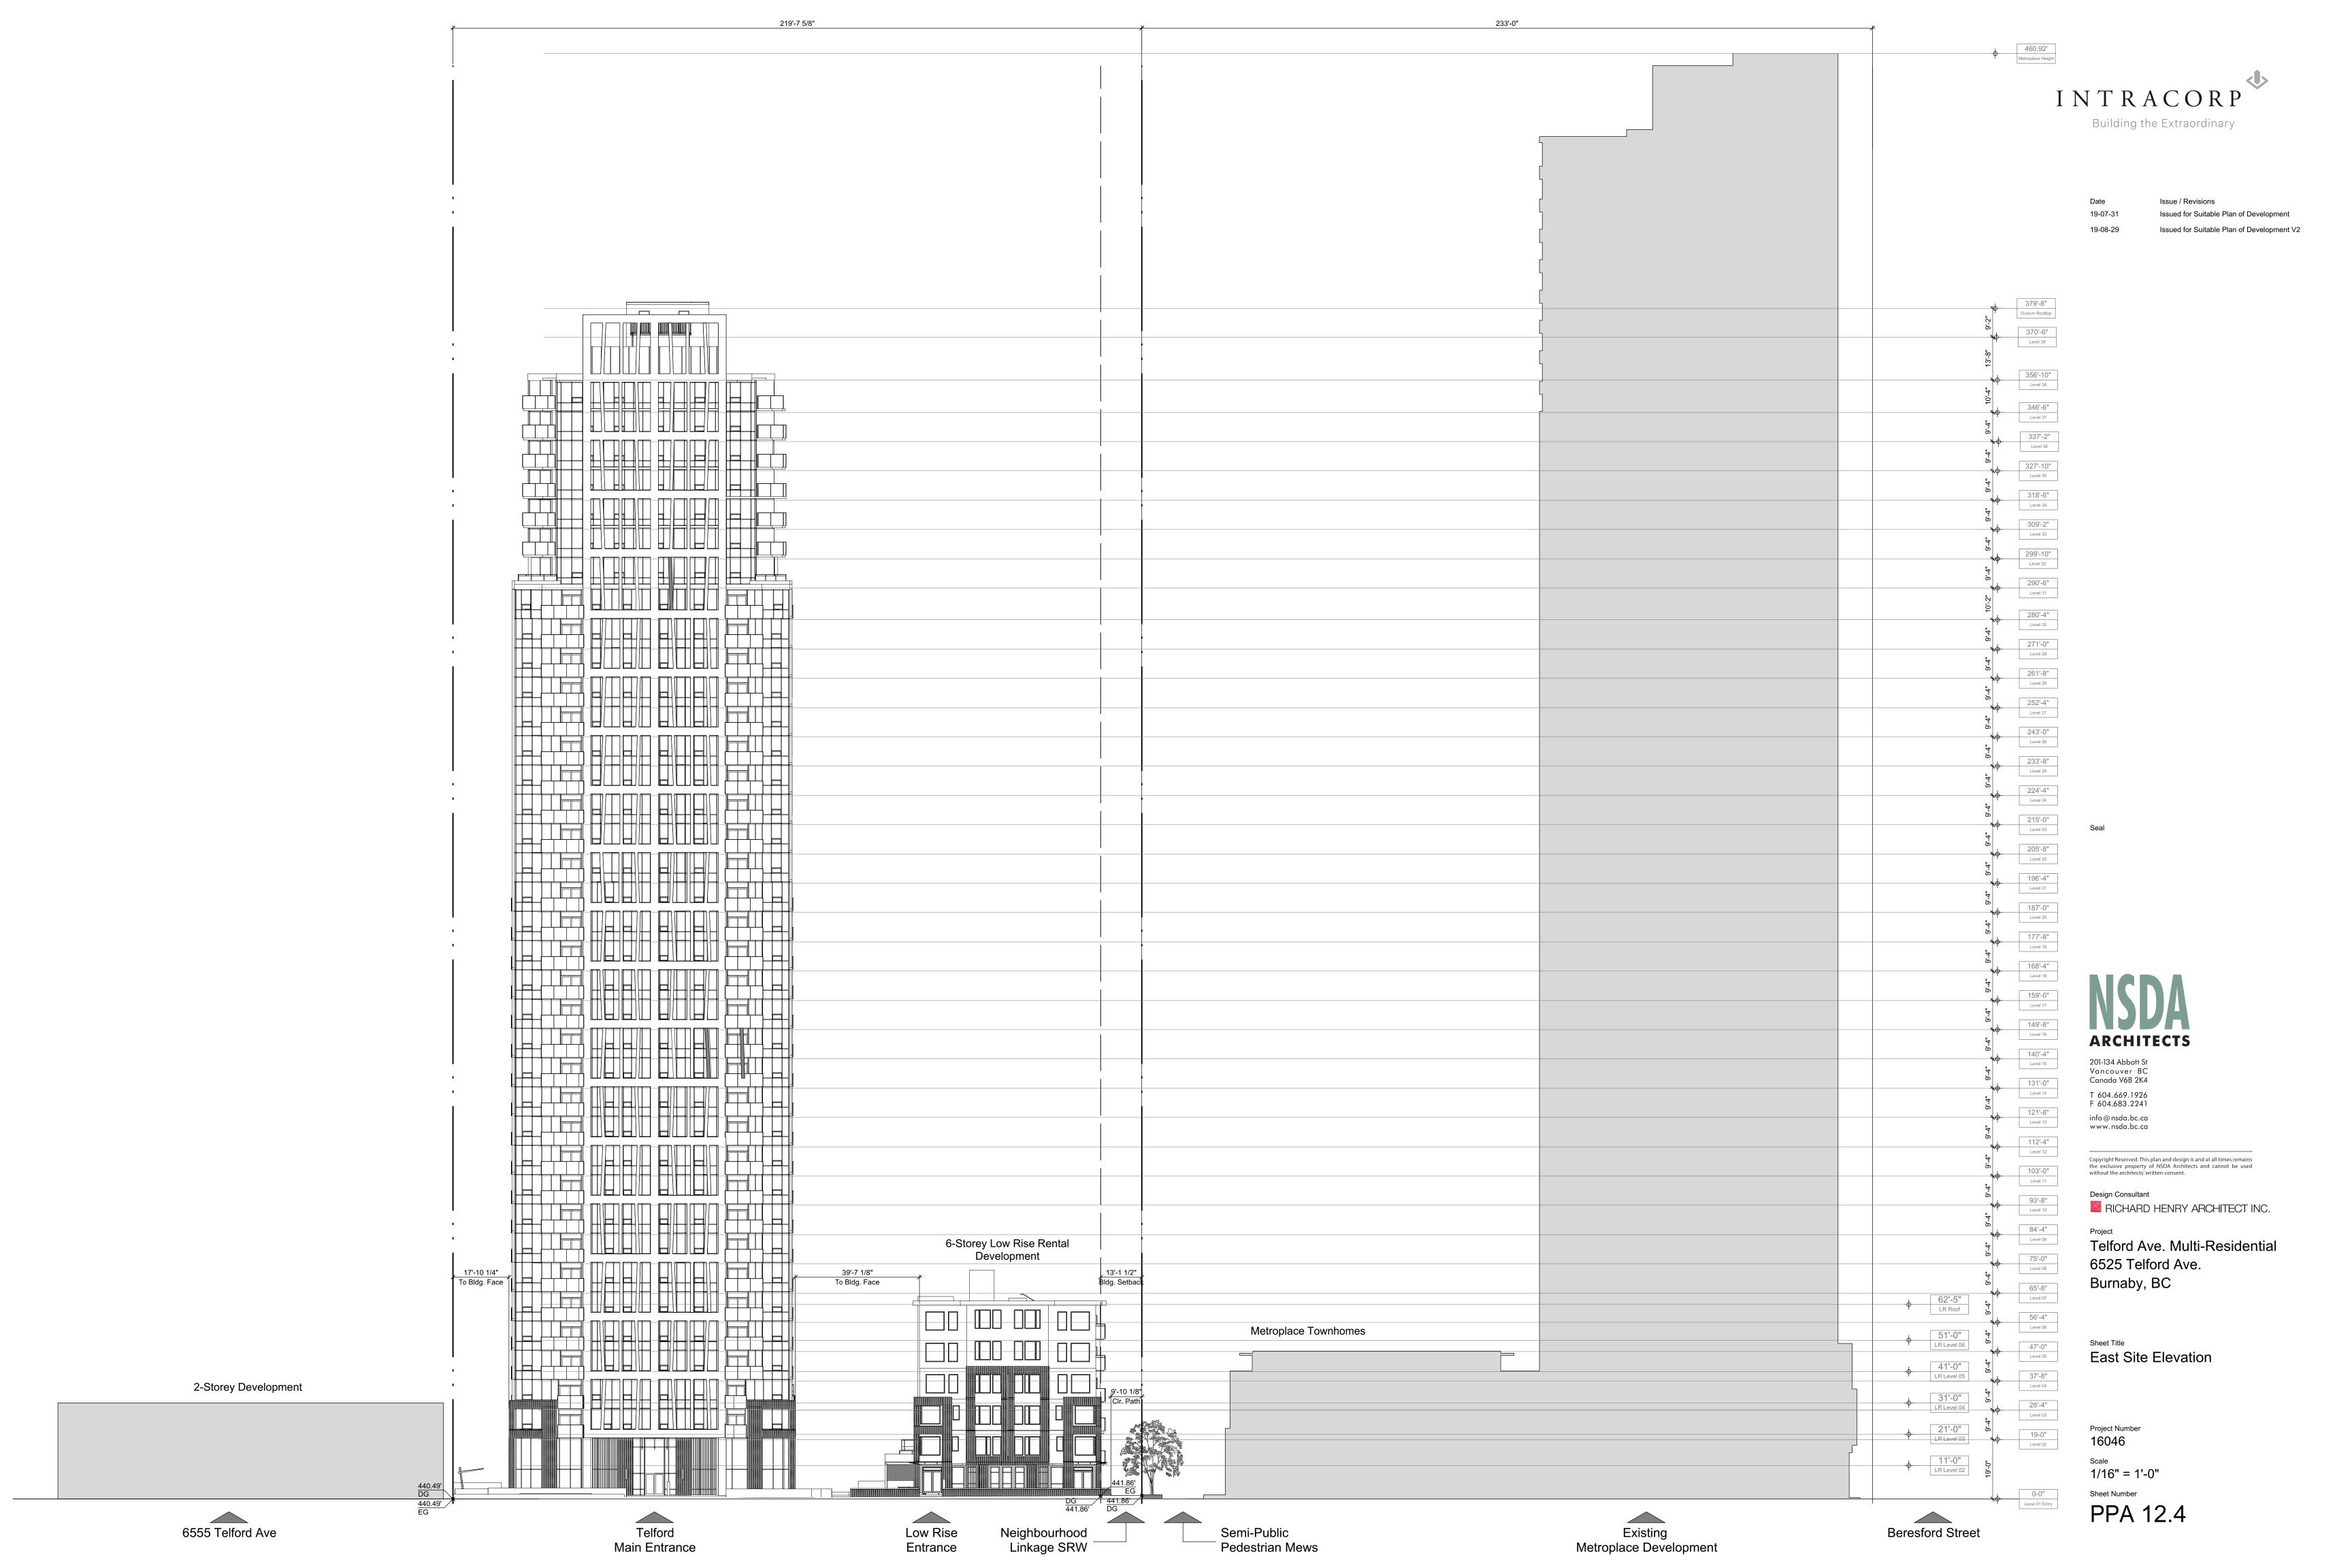
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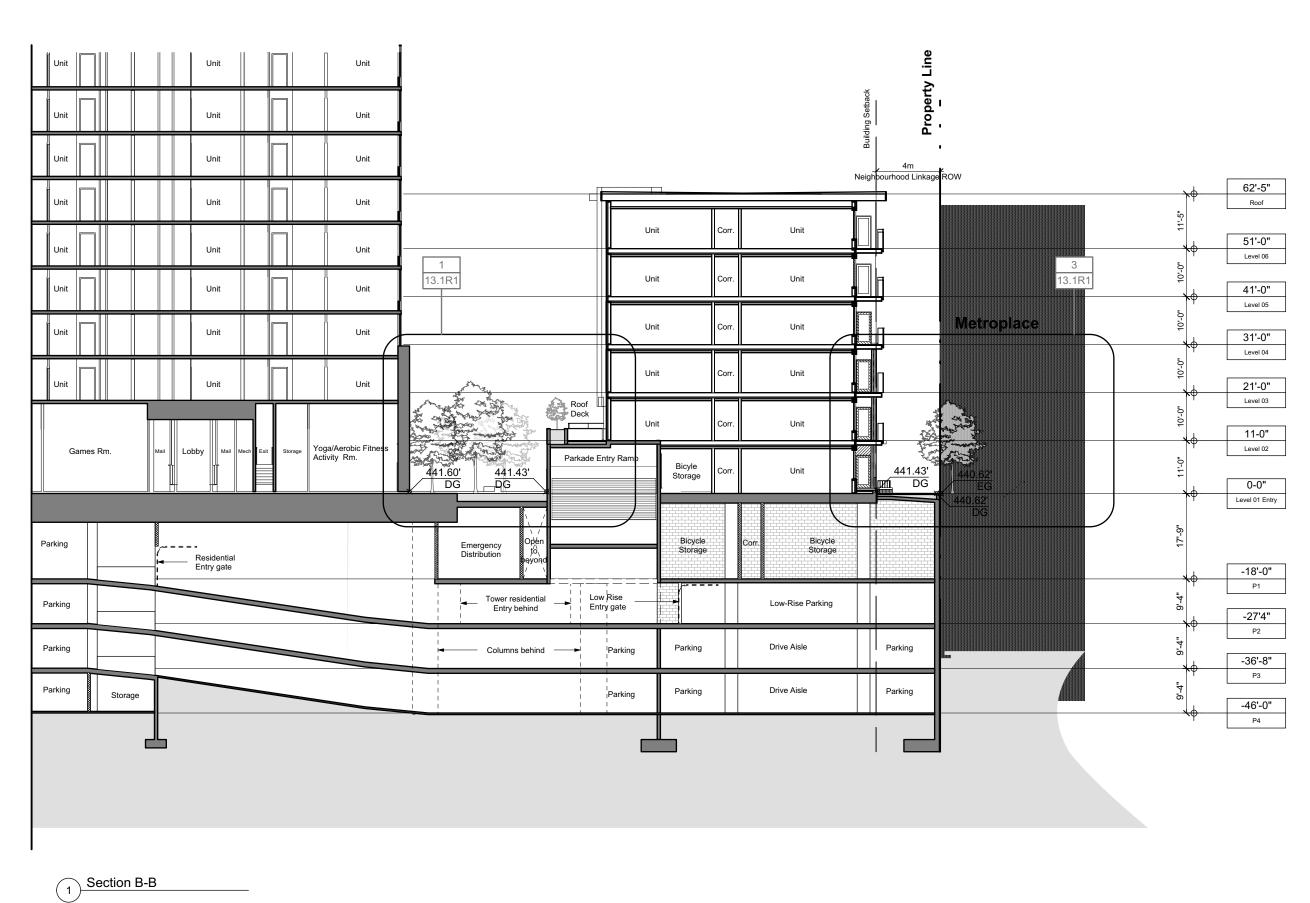
Sheet Title
West & South Elevations


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Scale

1/16" = 1'-0"


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Section C-C



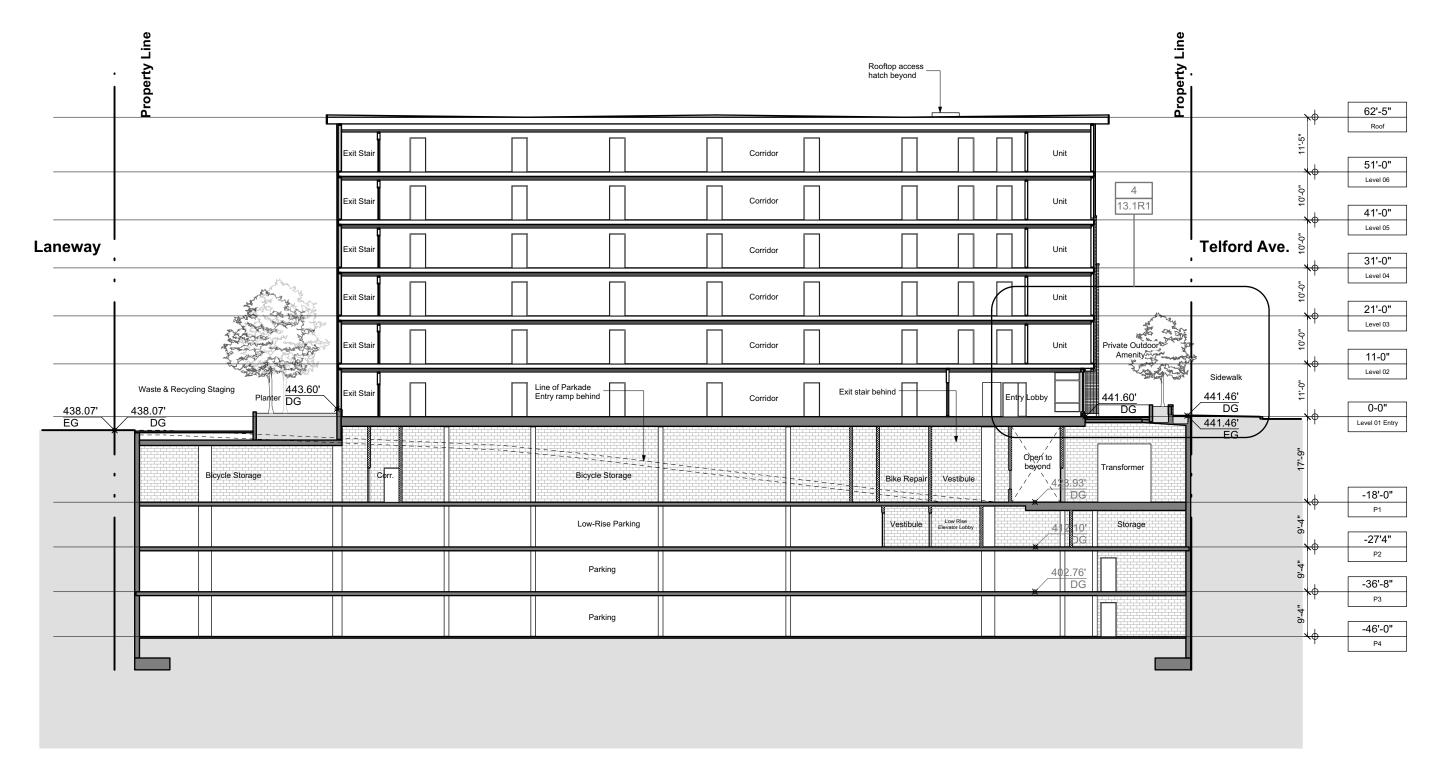

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# **ARCHITECTS**

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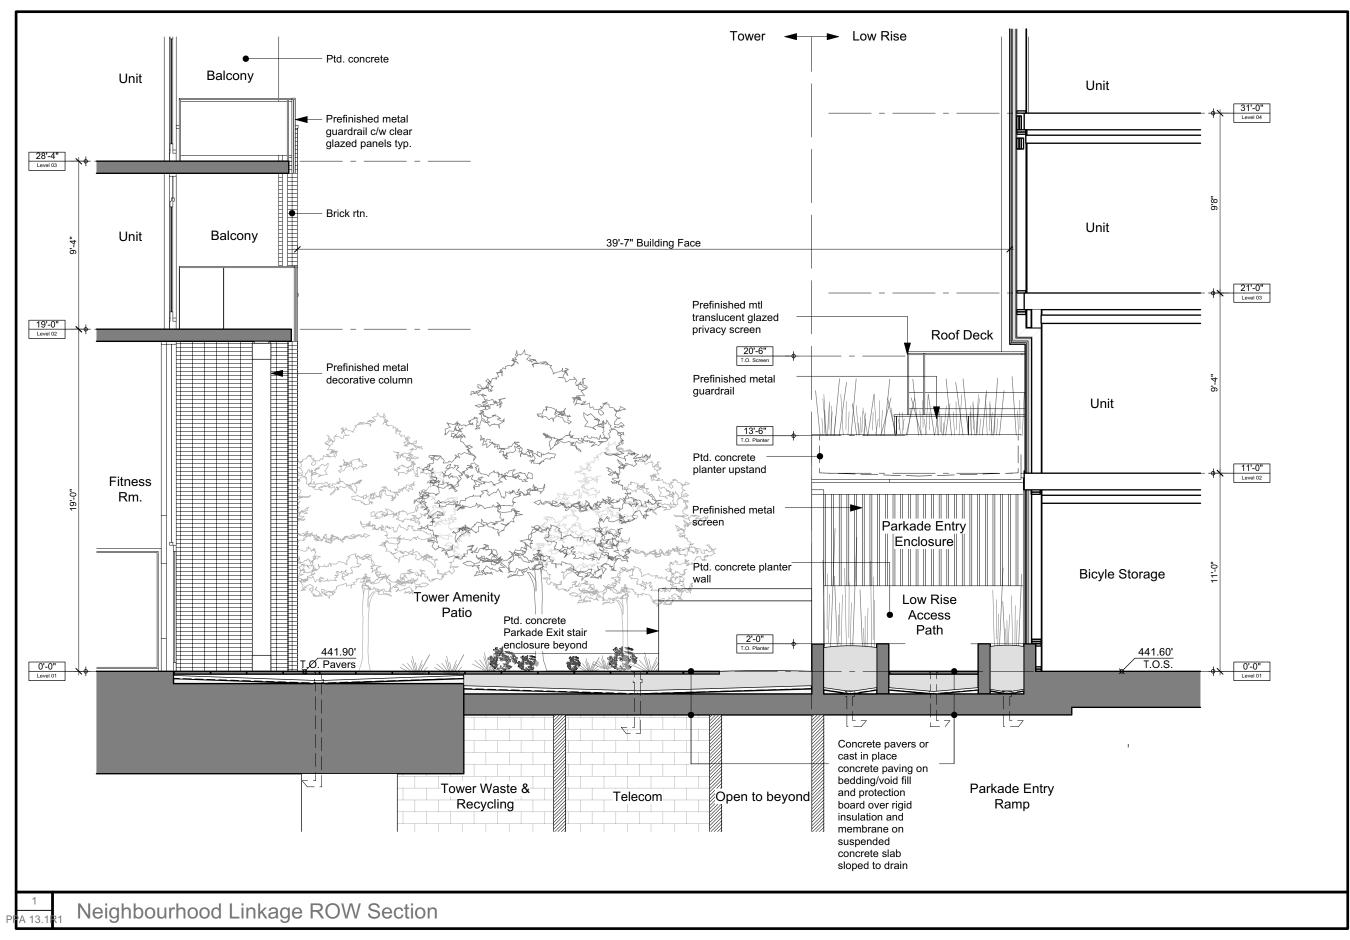
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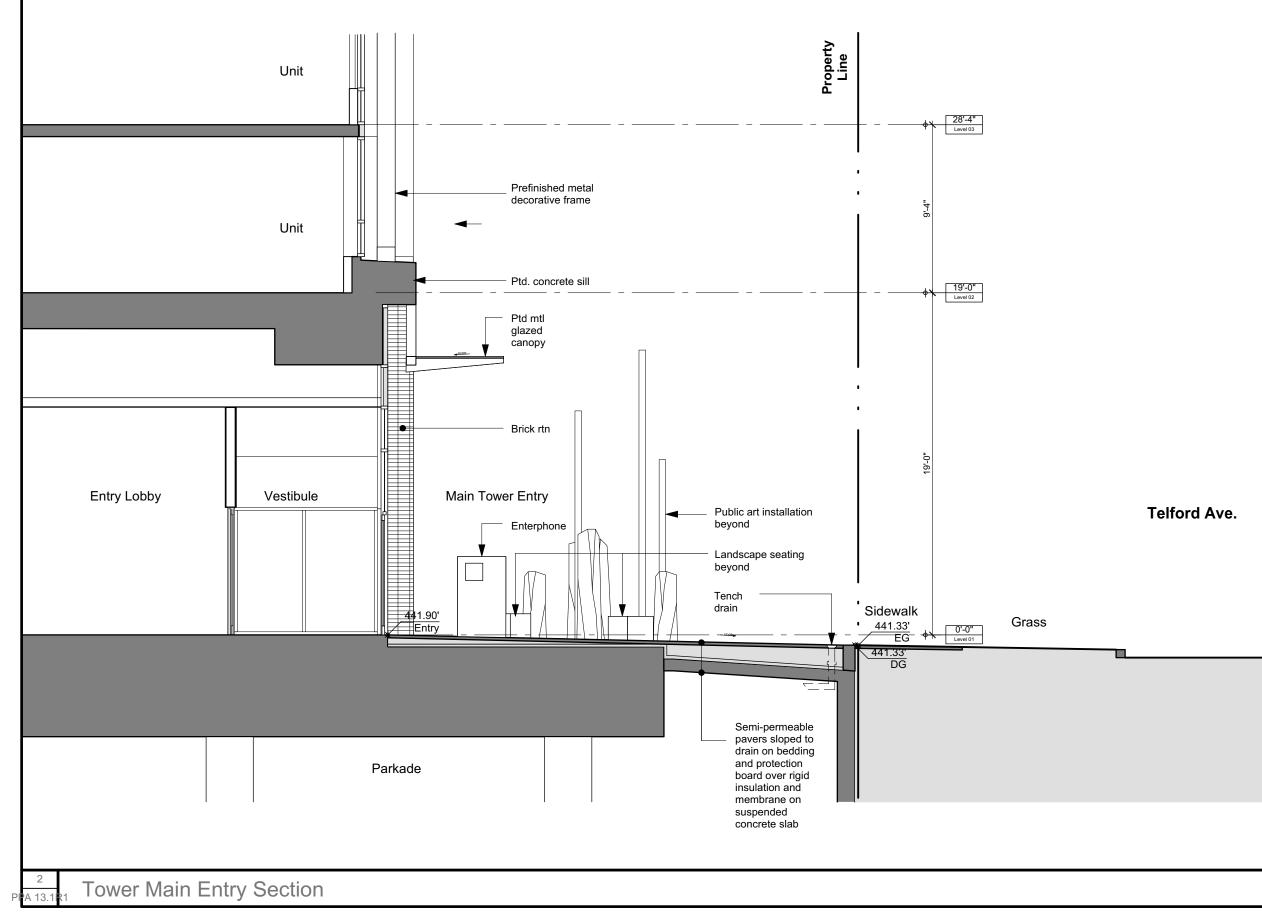
Burnaby, BC

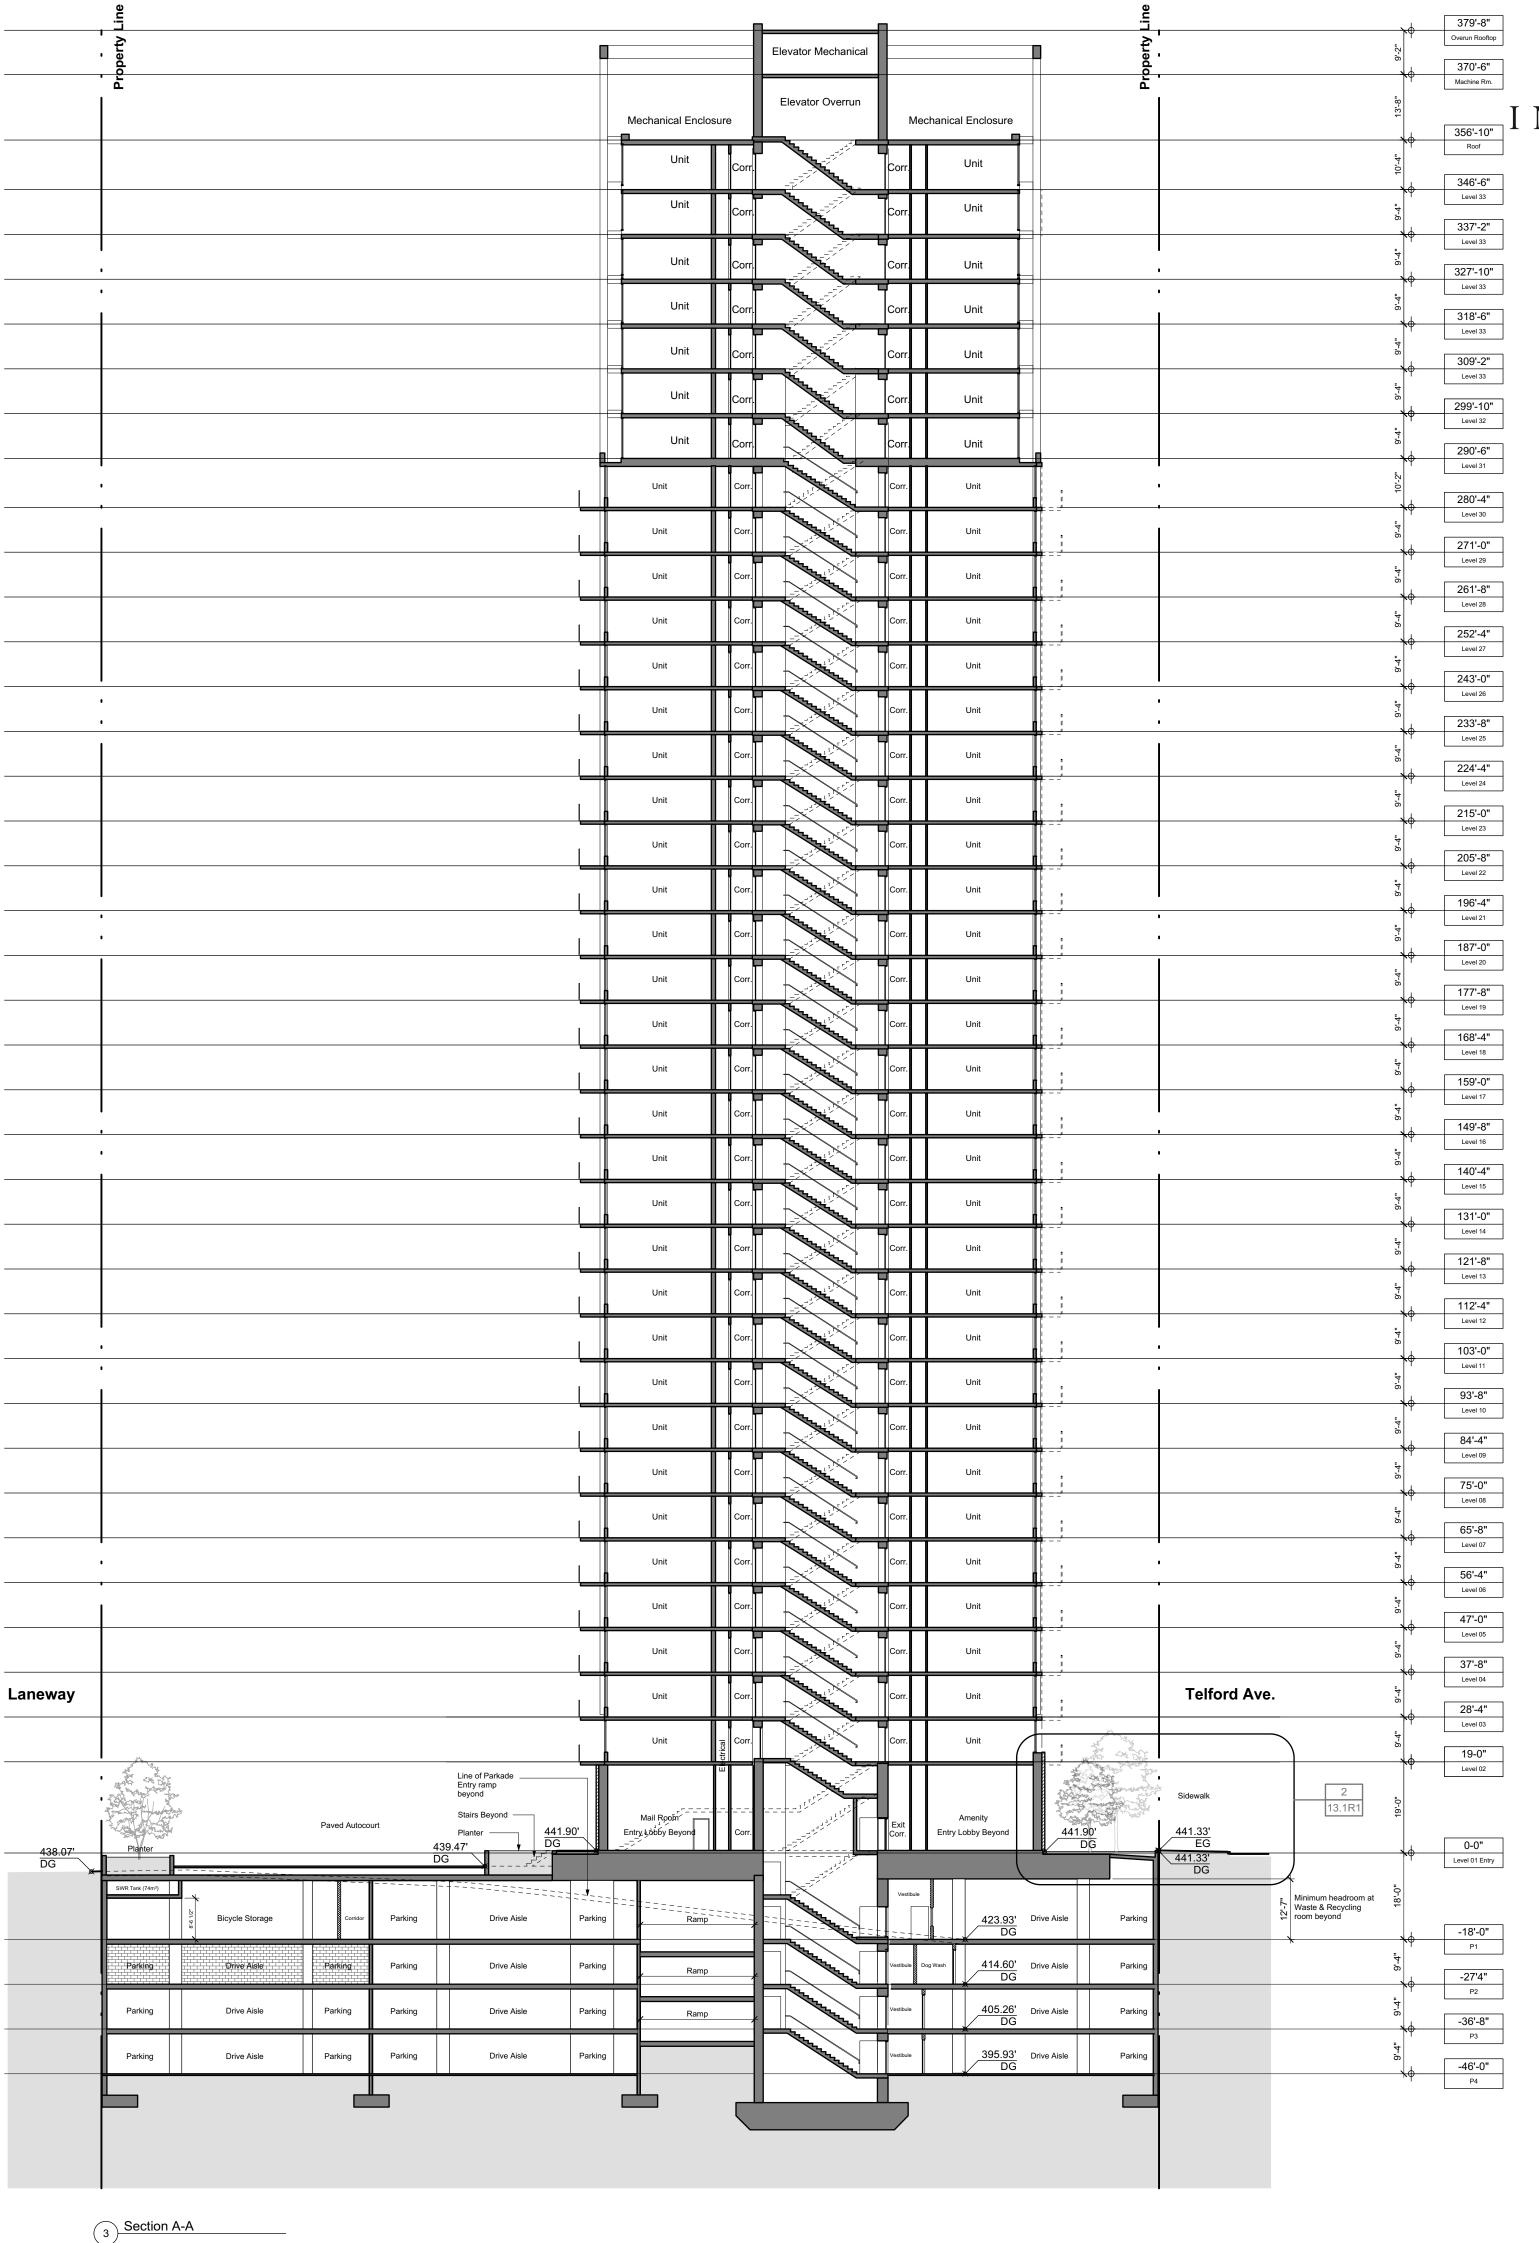
Project Number 16046


1" = 20'-0" Sheet Number

PPA 13.0R1





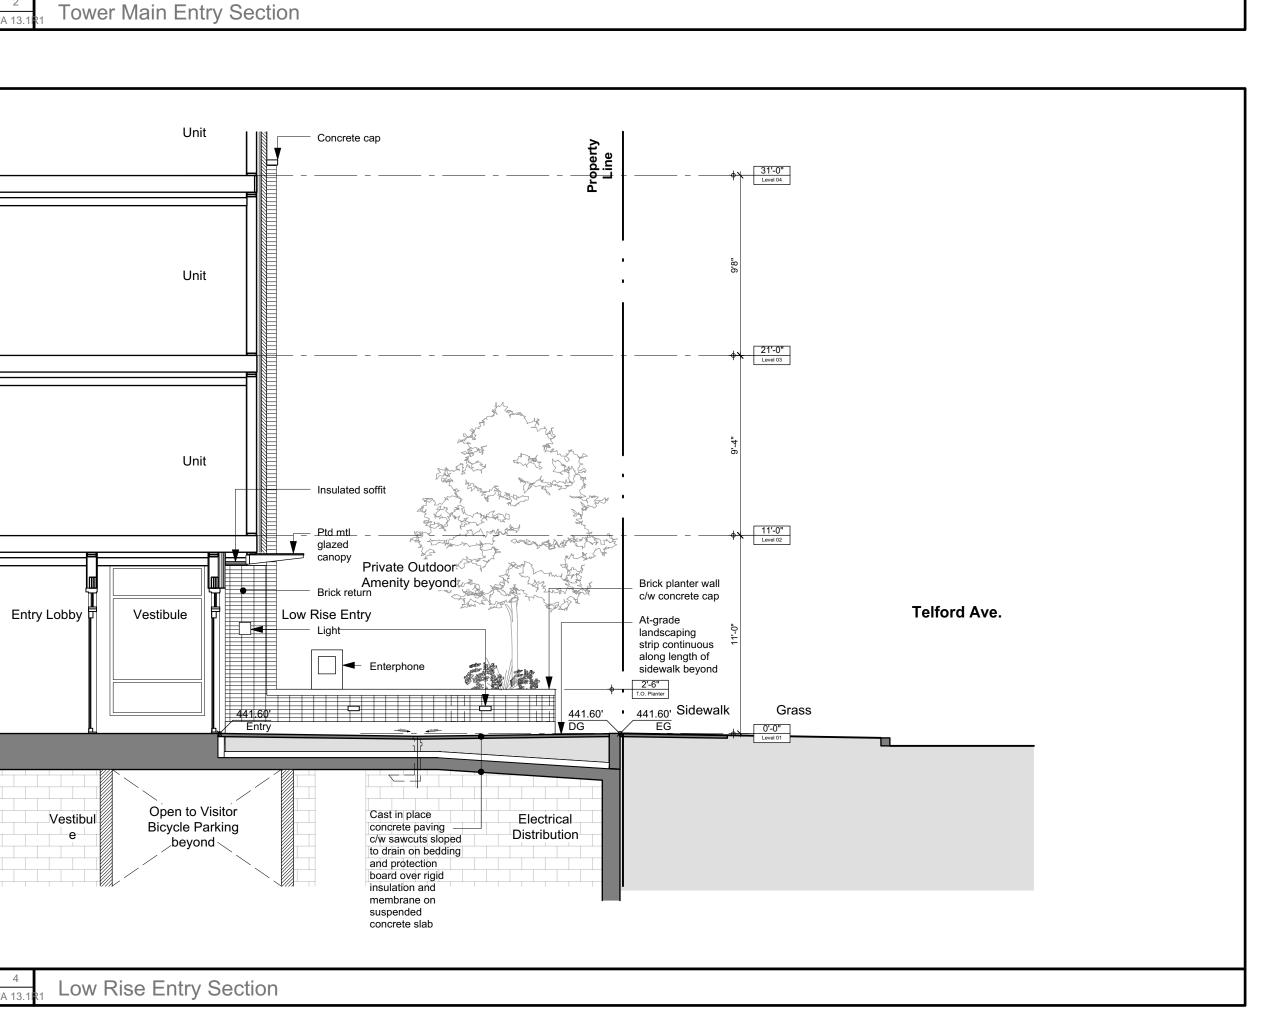

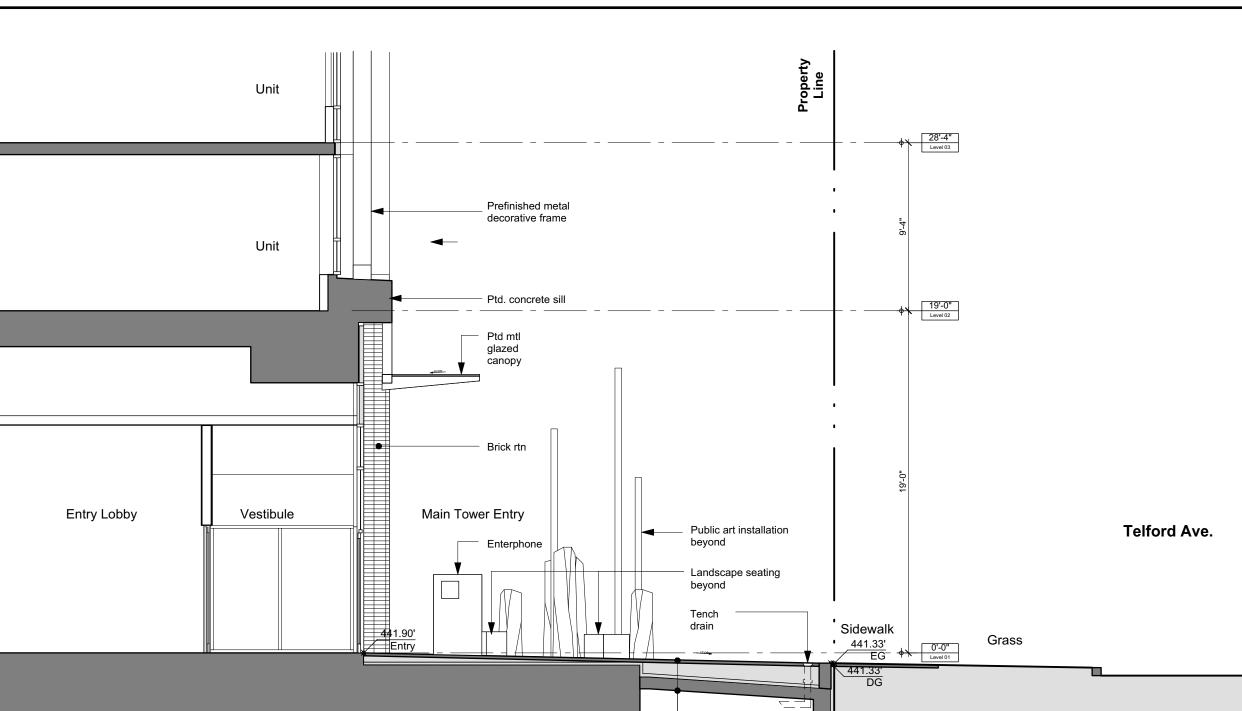



Issue / Revisions Issued for 3rd Reading Re-Issued for Suitable Plan of Development Re-Issued for 3rd Reading 19-1-14 Re-Issued for 3rd Reading

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Sheet Title **Detail Sections** 

Project Number 16046 3/16" = 1'-0" Sheet Number PPA 13.1R1

